



DEPARTMENT OF REGULATORY AND ECONOMIC RESOURCES (RER)
BOARD AND CODE ADMINISTRATION DIVISION

NOTICE OF ACCEPTANCE (NOA)

Peetz Windows and Doors, Inc.
15951 S.W. 41 Street, Suite 150
Weston, FL 33331

SCOPE:

This NOA is being issued under the applicable rules and regulations governing the use of construction materials. The documentation submitted has been reviewed and accepted by Miami-Dade County RER -Product Control Section to be used in Miami Dade County and other areas where allowed by the Authority Having Jurisdiction (AHJ).

This NOA shall not be valid after the expiration date stated below. The Miami-Dade County Product Control Section (In Miami Dade County) and/or the AHJ (in areas other than Miami Dade County) reserve the right to have this product or material tested for quality assurance purposes. If this product or material fails to perform in the accepted manner, the manufacturer will incur the expense of such testing and the AHJ may immediately revoke, modify, or suspend the use of such product or material within their jurisdiction. RER reserves the right to revoke this acceptance, if it is determined by Miami-Dade County Product Control Section that this product or material fails to meet the requirements of the applicable building code.

This product is approved as described herein, and has been designed to comply with the Florida Building Code, including the High Velocity Hurricane Zone.

DESCRIPTION: Series "American" Outswing Glazed Wood Doors – L.M.I.

APPROVAL DOCUMENT: Drawing No. 1324 Rev C, titled "American Outswing Impact Wood Door", sheets 1 thru 12 of 12, dated 05/07/10 and last revised on APR 06, 2015, prepared by W. W. Schafer Engineering & consulting, P. A., signed and sealed by Warren W. Schafer, P. E., bearing the Miami-Dade County Product Control Revision stamp with the Notice of Acceptance number and Expiration date by the Miami-Dade County Product Control Section.

MISSILE IMPACT RATING: Large and Small Missile Impact Resistant

Limitations:

1. For Transom (steel reinforced) mulled doors, lower design pressure of; fixed casement, direct glazed window (under separate NOA(s)) or doors in this NOA shall control.
2. For Vertical (steel reinforced) mulled doors, lower design pressure of; fixed panel door, fixed casement (under separate NOA(s)) or doors in this NOA shall control.
3. Hinges to be located 8" from top or bottom of frame and not to exceed =29" O.C.
4. Grouted CMU is required at side jambs and Transom ends.
5. Partial Raised panels and Partial Flush Panels are limited to max 28.937" W x 47" H.

LABELING: Each unit shall bear a permanent label with the manufacturer's name or logo, Kall/Eifel, Germany and series and following statement: "Miami-Dade County Product Control Approved", unless otherwise noted herein.

RENEWAL of this NOA shall be considered after a renewal application has been filed and there has been no change in the applicable building code negatively affecting the performance of this product.

TERMINATION of this NOA will occur after the expiration date or if there has been a revision or change in the materials, use, and/or manufacture of the product or process. Misuse of this NOA as an endorsement of any product, for sales, advertising or any other purposes shall automatically terminate this NOA. Failure to comply with any section of this NOA shall be cause for termination and removal of NOA.

ADVERTISEMENT: The NOA number preceded by the words Miami-Dade County, Florida, and followed by the expiration date may be displayed in advertising literature. If any portion of the NOA is displayed, then it shall be done in its entirety.

INSPECTION: A copy of this entire NOA shall be provided to the user by the manufacturer or its distributors and shall be available for inspection at the job site at the request of the Building Official.

This NOA revises & renews NOA #14-0429.01 and consists of this page 1 and evidence pages E-1, as well as approval document mentioned above.

The submitted documentation was reviewed by Ishaq I. Chanda, P.E.



NOTICE OF ACCEPTANCE: EVIDENCE SUBMITTED

A. DRAWINGS (Submitted under files# listed below)

1. Manufacturer's die drawings and sections.
2. Drawing No. **1324 Rev C**, titled "American Outswing Impact Wood Door", sheets 1 thru 12 of 12, dated 05/07/10 and last revised on APR 06, 2015, prepared by W. W. Schafer Engineering & Consulting, P. A., signed and sealed by Warren W. Schafer, P.E.

B. TESTS (Submitted under files#**14-0429.01/11-1024.15 /#10-0510.09**)

1. Test reports on: 1) Air Infiltration Test, per FBC, TAS 202-94
2) Uniform Static Air Pressure Test, Loading per FBC TAS 202-94
3) Water Resistance Test, per FBC, TAS 202-94
4) Large Missile Impact Test per FBC, TAS 201-94
5) Cyclic Wind Pressure Loading per FBC, TAS 203-94
6) Forced Entry Test, per FBC 2411 3.2.1, TAS 202-94

along with the manufacturer's parts drawings, installation diagram and marked-up drawings of a outswing wood door window prepared by Hurricane Test Laboratory, Inc. Test Report No. **HTL-0284-0114-04 & HTL-0284-0114-05**, both dated 06/03/05, signed & sealed by Vinu J. Abraham, P.E.

C. CALCULATIONS

1. Anchor verification calculations complying w/ FBC-2014 (5th Edition), dated APR 06, 2015, prepared, signed and sealed by Warren W. Schafer, P.E.
2. Glazing complies with ASTM E-1300-02 &-04.

D. QUALITY ASSURANCE

1. Miami Dade Department of Regulatory and Economic Resources (RER).

E. MATERIAL CERTIFICATIONS


1. Notice of Acceptance No. **12-1231.08** issued to Eastman Chemical Co(MA) former Solutia Inc., for "Saflex CP: Saflex & Saflex HP Composite Glass Interlayer w/ PET", expiring on 12/11/2018.
2. Notice of Acceptance No. **12-1231.09** issued to Eastman Chemical Co (MA) former Solutia Inc. for "Saflex Clear or colored interlayer", expiring on May 21, 2016.

F. STATEMENTS

1. Statement letter of conformance to FBC 2014(5th Edition) and letter of no financial interest, prepared by W. W. Schaefer Engineering & Consulting, P.A., dated April 06, 2015, signed and sealed by Warren W. Schaefer, P.E.
2. Statement letter, prepared by W. W. Schaefer Engineering & Consulting, P.A. dated April 06, 2015, of NOA Drawings and calculation have been reviewed to 2014 FBC and found compliant and changes to existing NOA documents are noted in the letter, signed by Warren W. Schaefer, P.E.
3. Statement letters of conformance to FBC 2010, dated OCT 19, 2011, prepared by W. W. Schafer Engineering & Consulting, P. A., signed and sealed by Warren W. Schafer, P.E. (submitted under file #11-1024.15).
4. Distributor Agreement dated August 18, 2010, between Helmut Peetz, GMBH and Peetz Windows and Doors, Inc., signed respectively by Christian Peetz, President of Helmut Peetz, GmbH, and by Eva Leon, V. P. of Peetz Windows and Doors, Inc. (submitted under file #11-1024.15)
5. Lab compliance as part of the above referenced test report.

G. OTHER

1. This NOA revises & renews NOA # **14-0429.01**, expiring on 08/18/20.
2. Test Proposals # **04-0340**, approved by BCCO.

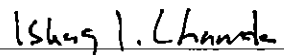
Ishaq I. Chanda, P.E.

Product Control Examiner
NOA No. 15-0414.11

Expiration Date: August 18, 2020

Approval Date: July 16, 2015

GENERAL NOTES:

- THIS PRODUCT HAS BEEN TESTED, ANALYZED & APPROVED FOR DESIGN PRESSURES NOT TO EXCEED THOSE SHOWN IN THE "ALLOWABLE DESIGN PRESSURE TABLE(S)".
- OPENINGS, BUCKING & BUCKING FASTENERS MUST BE PROPERLY DESIGNED & INSTALLED TO TRANSFER WIND LOADS TO THE STRUCTURE.
- ALL HARDWARE & FASTENERS SHALL BE IN ACCORDANCE WITH THESE DRAWINGS & SHALL NOT VARY UNLESS SPECIFICALLY MENTIONED ON THE DRAWINGS. SPECIFIED ANCHOR EMBED TO BASE MATERIAL SHALL BE BEYOND WALL FINISH OR STUCCO.
- THE DETAILS & SPECIFICATIONS SHOWN HEREIN REPRESENT THE PRODUCTS TESTED & PROPOSED FOR CONFORMANCE WITH THE FLORIDA BUILDING CODE PROTOCOLS TAS-201, 202 & 203 FOR LARGE MISSILE IMPACT PRODUCTS.
- THIS PRODUCT HAS BEEN DESIGNED IN ACCORDANCE WITH AND MEETS THE REQUIREMENTS OF THE FLORIDA BUILDING CODE (FBC) INCLUDING HIGH VELOCITY HURRICANE ZONES (HVHZ).
- IMPACT SHUTTERS ARE NOT REQUIRED WITH THIS PRODUCT.
- ALL ANCHORS SECURING PRODUCT FRAMES TO PRESSURE TREATED BUCKS OR WOOD FRAMING SHALL BE CAPABLE OF RESISTING CORROSION CAUSED BY THE PRESSURE TREATING CHEMICALS IN THE WOOD.
- DETERMINE THE POSITIVE & NEGATIVE DESIGN LOADS TO USE WHEN REFERENCING THESE DOCUMENTS IN ACCORDANCE WITH THE GOVERNING CODE AND GOVERNING WIND VELOCITY. FOR WIND LOAD CALCULATIONS IN ACCORDANCE WITH THE FLORIDA BUILDING CODE, A DIRECTIONALITY FACTOR OF $K_d = 0.85$ MAY BE APPLIED PER THE ASCE-7 STANDARD.
- NO INCREASE IN ALLOWABLE STRESS HAS BEEN USED IN THE CERTIFICATION OF THIS PRODUCT. WIND LOAD DURATION FACTOR $C_d = 1.6$ WAS USED FOR WOOD SCREW ANALYSIS ONLY.
- MATERIALS, INCLUDING BUT NOT LIMITED TO STEEL SCREWS, THAT COME INTO CONTACT WITH OTHER DISSIMILAR MATERIALS SHALL MEET THE REQUIREMENTS OF FLORIDA BUILDING CODE.
- ALL WOOD MEMBERS OF THIS PRODUCT THAT MAY POSSIBLY COME INTO CONTACT WITH MASONRY OR CONCRETE SUBSTRATES, ARE SUBJECT TO MOISTURE &/OR ARE SUBJECT TO THE OUTSIDE ENVIRONMENT SHALL BE OF AN APPROVED DURABLE SPECIES OR BE TREATED IN AN APPROVED METHOD WITH AN APPROVED PRESERVATIVE PER FBC REQUIREMENTS.

HINGE TABLE


DOOR SHAPE	HINGE REQUIREMENTS
HALF-ROUND TOP	CENTERLINE OF HINGES SHALL BE LOCATED 8" FROM BOTTOM OF DOOR PANEL, 2 3/4" FROM SPRINGLINE AND MAX. 28 1/2" O.C. BETWEEN.
ALL OTHER SHAPES	CENTERLINE OF HINGES SHALL BE LOCATED 8" FROM TOP & BOTTOM OF DOOR PANEL CORNERS AND MAX. 28 1/2" O.C. BETWEEN.

FRAME ANCHOR REQUIREMENTS TABLE

OPENING TYPE (SUBSTRATE)	FRAME/CLIP/BACKET TO OPENING FASTENER TYPE	MINIMUM EMBED	MINIMUM EDGE DIST.
FRAME/SILL SCREWS			
MIN. 2X4 WOOD FRAME OR BUCK (MIN. GR. 3 & G=0.55)	NO. 14 SMS OR WOOD SCREW	1 1/4"	1"
MIN. 16 GA. 50 KSI METAL STUD	NO. 14 GR. 5 SELF TAP/DRILL SCREW	FULL	1/2"
MIN. 1/8" THK A36 STEEL	NO. 14 GR. 5 SELF TAP/DRILL SCREW	FULL	1/2"
MIN. C-90 CMU	(1) 1/4" CONCRETE SCREW	1 1/4"	2 1/2"
2500 PSI CONCRETE	(1) 1/4" CONCRETE SCREW	1 1/2"	2 1/2"
MOUNTING CLIP SCREWS			
MIN. 2X4 WOOD FRAME OR BUCK (MIN. GR. 3 & G=0.55)	NO. 8 SMS OR WOOD SCREW	1 3/8"	1/2"
MIN. 1/8" THK A36 STEEL	NO. 8 GR. 5 SELF TAP/DRILL SCREW	FULL	1/2"
(2) MOUNTING BRACKET SCREWS			
MIN. 2X6 WOOD FRAME OR BUCK (MIN. GR. 3 & G=0.55)	NO. 8 SMS OR WOOD SCREW	1 3/8"	1/2"
MIN. 18 GA. 33 KSI METAL STUD	NO. 8 GR. 5 SELF TAP/DRILL SCREW	FULL	1/2"
MIN. 1/8" THK A36 STEEL	NO. 8 GR. 5 SELF TAP/DRILL SCREW	FULL	1/2"

- CONCRETE SCREWS SHALL BE ELCO ULTRACONS (C.S.), ELCO CRETE-FLEX (S.S.), ITW RAMSET/RED HEAD TAPCONS (C.S. OR S.S.) OR HILTI KWIK-CON II (C.S. OR S.S.).
- MOUNTING BRACKETS MAY BE USED WITH A CONCRETE SUBSTRATE AT THE SILL ONLY.


FRAME/SILL SCREWS, MOUNTING CLIPS, OR MOUNTING BRACKETS WHERE SHOWN. SEE "FRAME ANCHOR REQUIREMENTS TABLE" ON THIS SHEET FOR REQUIREMENTS.

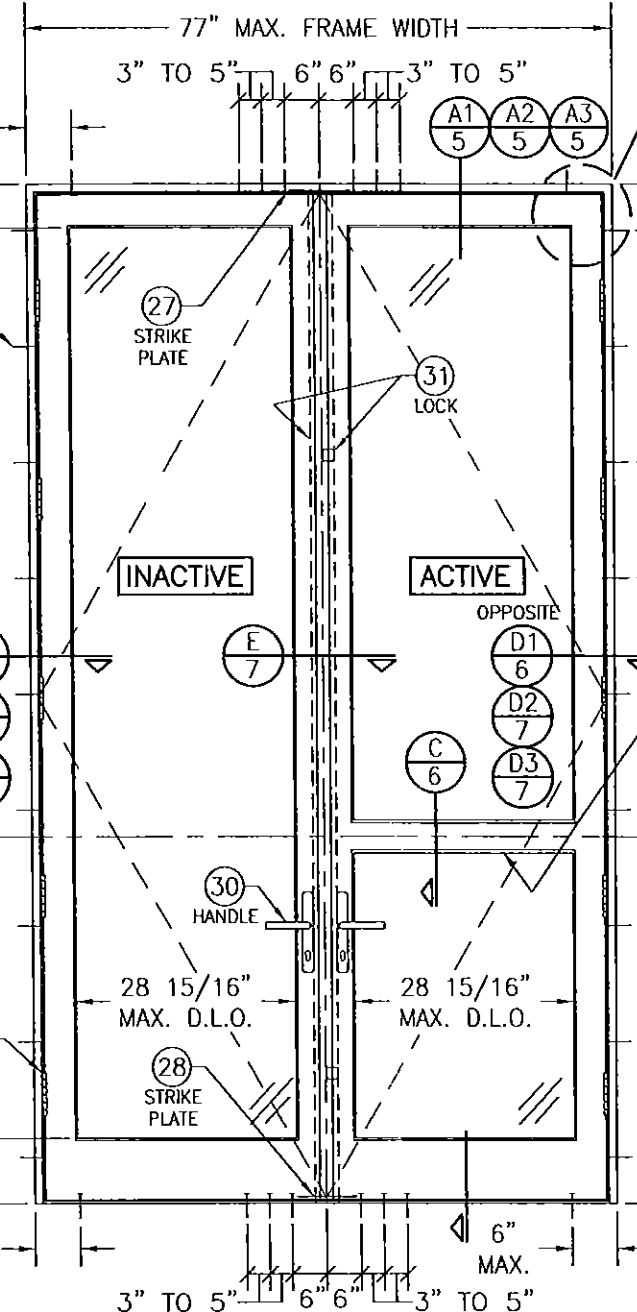

EXTERIOR ELEVATION
DOUBLE RECTANGULAR OUTSWING DOOR
SCALE: 1/2" = 1'-0"

SEE "CORNER CONSTRUCTION" DESCRIPTION ON THIS SHEET

FRAME/SILL SCREWS, MOUNTING CLIPS, OR MOUNTING BRACKETS WHERE SHOWN. SEE "FRAME ANCHOR REQUIREMENTS TABLE" ON THIS SHEET FOR REQUIREMENTS.

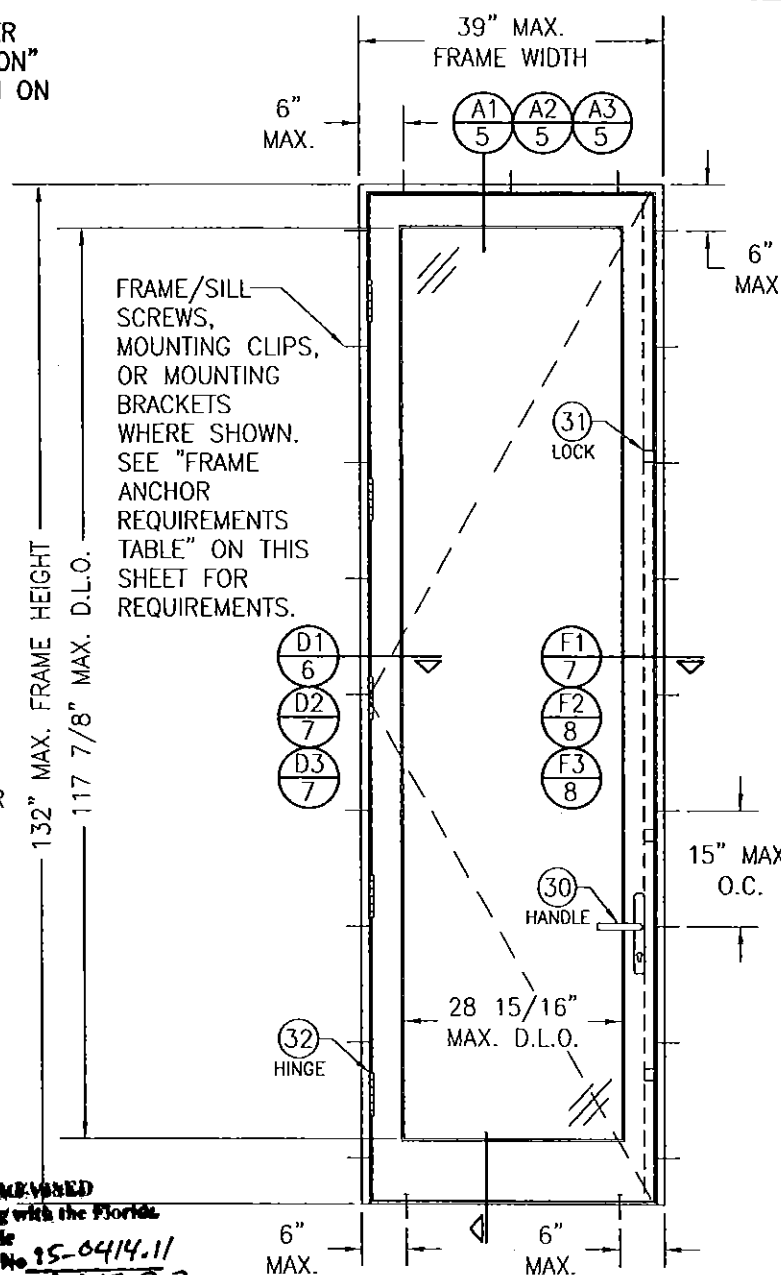


EXTERIOR ELEVATION
SINGLE RECTANGULAR OUTSWING DOOR
SCALE: 1/2" = 1'-0"

PRODUCT REVIEWED
as complying with the Florida
Building Code
Acceptance No. 95-0414.11
Expiration Date Aug 15, 2020
By Ishag L. Chaudhry
Statewide Product Control

ALLOWABLE DESIGN PRESSURE
(ALL DOOR CONDITIONS)
+/- 70 PSF

APPROVED SHAPES

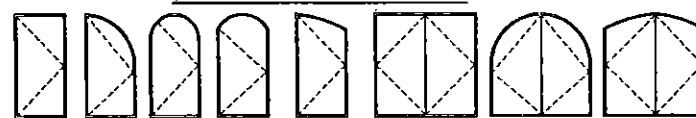

NOTES:


- OTHER SHAPES MAY APPLY PROVIDING THEY ARE SIMILAR TO THOSE SHOWN & HAVE CORNER CONSTRUCTION AS DESCRIBED ON THIS SHEET.
- ALL SHAPED UNITS MUST FIT INSCRIBED INTO THE ALLOWABLE RECTANGULAR UNITS & BE GOVERNED BY THE ALLOWABLE PRESSURE OF THE RESPECTIVE RECTANGULAR UNIT.

CORNER CONSTRUCTION:

- JAMBS: COPE, BUTTED TOGETHER, JOINED WITH 3 NO. 10 X 3 1/8" SCREWS & GLUED WITH BINDAN D4 OR EQUAL.
- SASH: MULTI-FORKED, BUTTED & GLUED WITH BINDAN D4 OR EQUAL, OR COPE, BUTTED TOGETHER & JOINED WITH (6) 3/8" X 3 15/16" WOOD DOWELS & GLUED WITH BINDAN D4 OR EQUAL.


THESE DRAWINGS ARE APPLICABLE ONLY TO THE PRODUCT SPECIFIED. THEY MAY NOT BE USED FOR THE ASSEMBLY AND/OR INSTALLATION OF ANY OTHER PRODUCT NOR MAY THEY BE USED FOR RATIONAL AND/OR LOCAL APPROVAL OF ANY PRODUCT NOT PRODUCED BY THE MANUFACTURER STATED ON THESE DRAWINGS.

DRAWN BY: S.T.R.		CHECKED BY: W.W.S.	
PLOT: 1=24		DATE: 3/22/05	
DATE	BY	REVISION	DESCRIPTION
05/07/10	WRM	A1	UPDATE TO PRESENT STANDARDS
10/19/11	WRM	B1	CHANGE CONSULTANTS ADDRESS
04/06/15	WWS	C1	UPDATE TO PRESENT STANDARDS
DRAWING TITLE: AMERICAN OUT-SWING IMPACT WOOD DOORS			
MANUFACTURER: PEETZ WINDOWS & DOORS			
15951 S.W. 41ST STREET, SUITE 150			
WESTON, FL 33331			
954-659-3887			
CONSULTANTS: W. W. SCHAEFER ENGINEERING & CONSULTING, P.A. (CA 6809)			
7480 150TH COURT NORTH			
PALM BEACH GARDENS, FL 33418			
PHONE: 561-744-3424			
CERTIFICATION: APR 06 2005			
DRAWING NO. 1324			
REV. C			
SHEET NO. 1 OF 12			

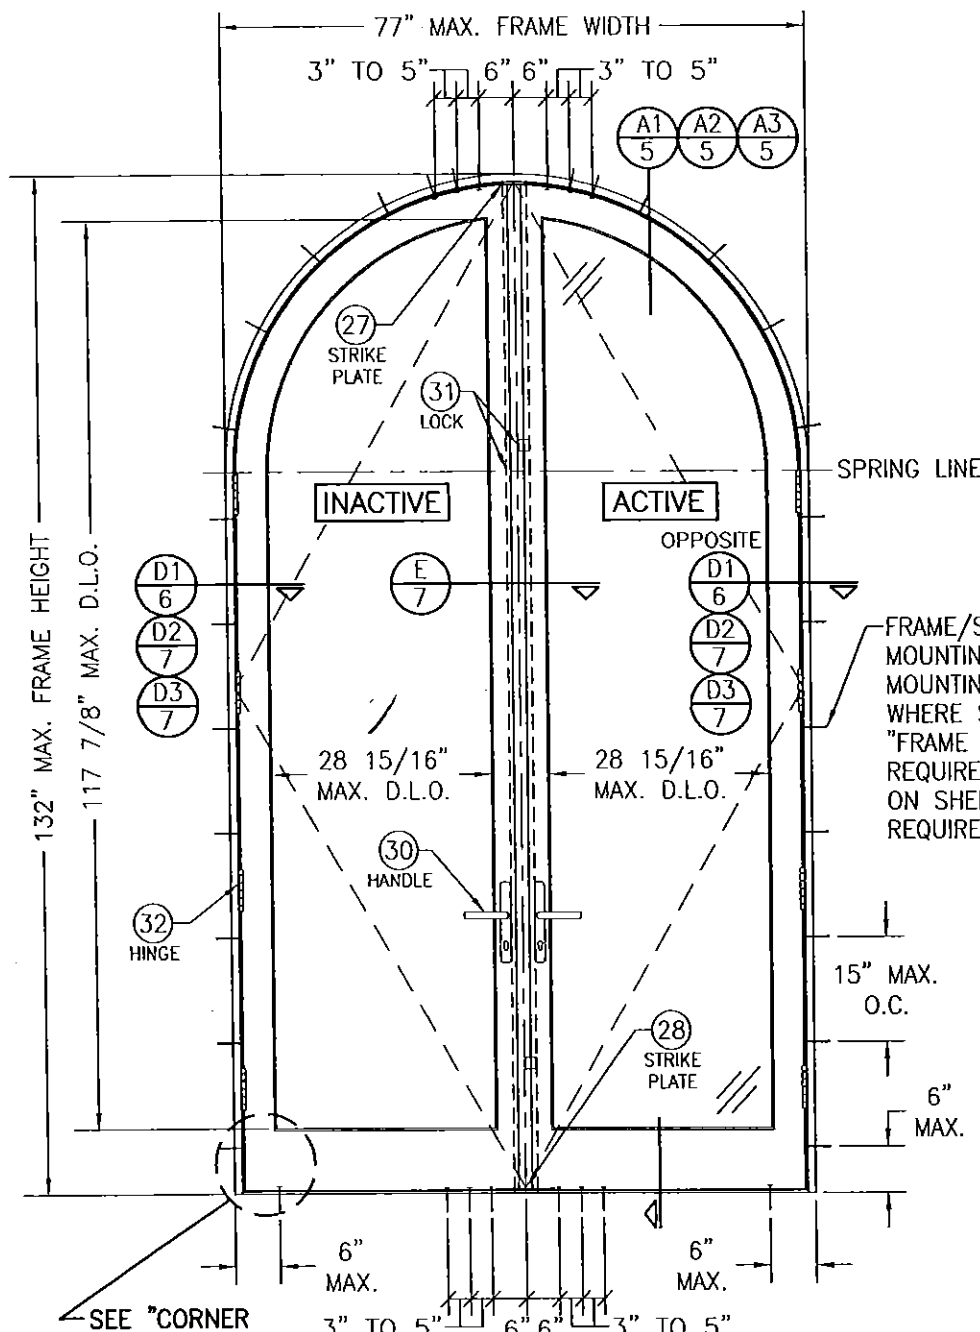

**EXTERIOR ELEVATION
DOUBLE HALF ROUND DOOR**

SCALE: 1/2" = 1'-0"
(OTHER SHAPES APPLY. SEE SHAPES TABLE ON SHEET 1)

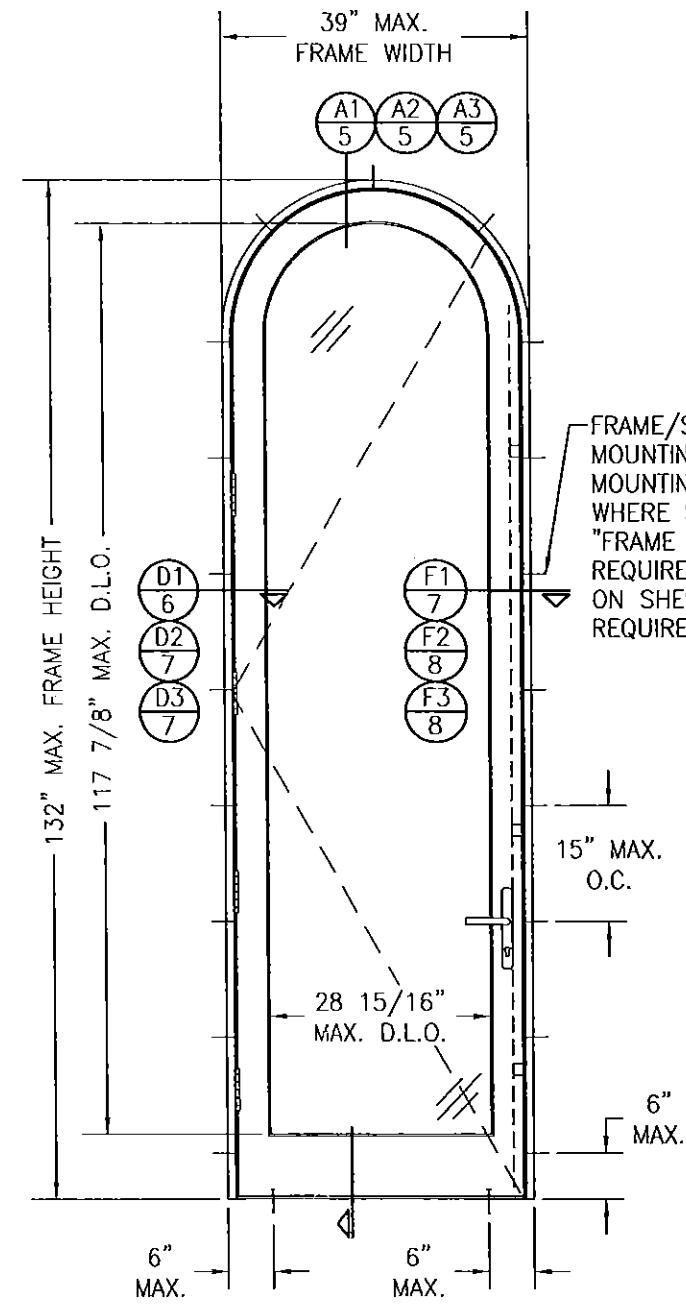


**EXTERIOR ELEVATION
SINGLE HALF ROUND DOOR**

SCALE: 1/2" = 1'-0"
(OTHER SHAPES APPLY. SEE SHAPES TABLE ON SHEET 1)

FRAME/SILL SCREWS,
MOUNTING CLIPS, OR
MOUNTING BRACKETS
WHERE SHOWN. SEE
"FRAME ANCHOR
REQUIREMENTS TABLE"
ON SHEET 1 FOR
REQUIREMENTS.

PRODUCT REVISED
As complying with the Florida
Building Code
Acceptance No. 15-041411
Expiration Date 8/18/20
By: [Signature]
Miami Dade Product Control

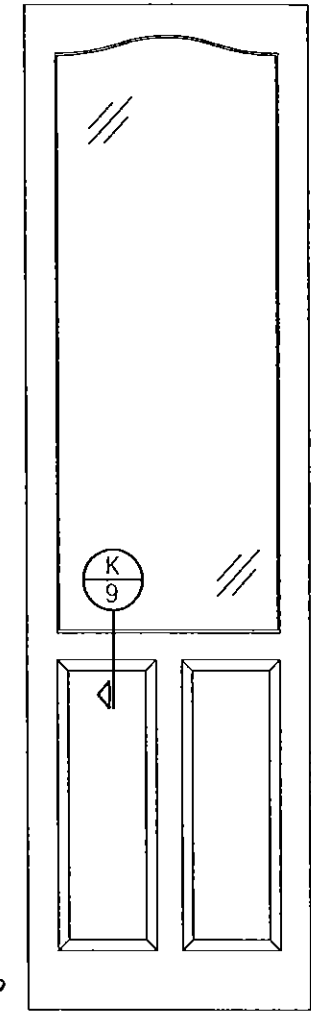


**EXTERIOR ELEVATION SOLID
RAISED PANEL WITH
STANDARD MID RAILS**

SCALE: 1/2" = 1'-0"

1. TOP & MID RAILS MAY BE OF ANY CONFIGURATION PROVIDING THE SMALLEST CROSS SECTION OF RAILS IS EQUAL TO OR LARGER THAN THAT DETAILED IN DRAWINGS.
2. MULTIPLE MID RAIL (BOTH HORIZONTAL & VERTICAL) MAY BE USED WITH THESE PANELS.
3. PARTIAL PANEL CONDITION IS SHOWN ABOVE. FULL PANEL DOORS AND OTHER PANEL CONFIGURATIONS ARE ALSO PART OF THIS APPROVAL AND ARE SIMILAR IN CONSTRUCTION TO THAT SHOWN ABOVE.
4. PANEL ONLY IS SHOWN. FOR INSTALLATION INTO FRAME, SEE OTHER ELEVATIONS.


DRAWN BY: S.T.R.		CHECKED BY: W.W.S.	
PLOT: 1=24		DATE: 3/22/05	
NO.	REVISION	DESCRIPTION	DATE
DRAWING TITLE AMERICAN OUT-SWING IMPACT WOOD DOORS			
CONSULTANTS W. W. SCHAEFER ENGINEERING & CONSULTING, P.A. (CA 6809)		MANUFACTURER PEETZ WINDOWS & DOORS 15951 S.W. 41ST STREET, SUITE 150 WESTON, FL 33331 954-659-3887	
7480 150TH COURT NORTH PALM BEACH GARDENS, FL 33418 PHONE: 561-744-3424		CERTIFICATION APR 06 2015	
DRAWING NO. 1324		REV. C	
SHEET NO. 2		OF 12	

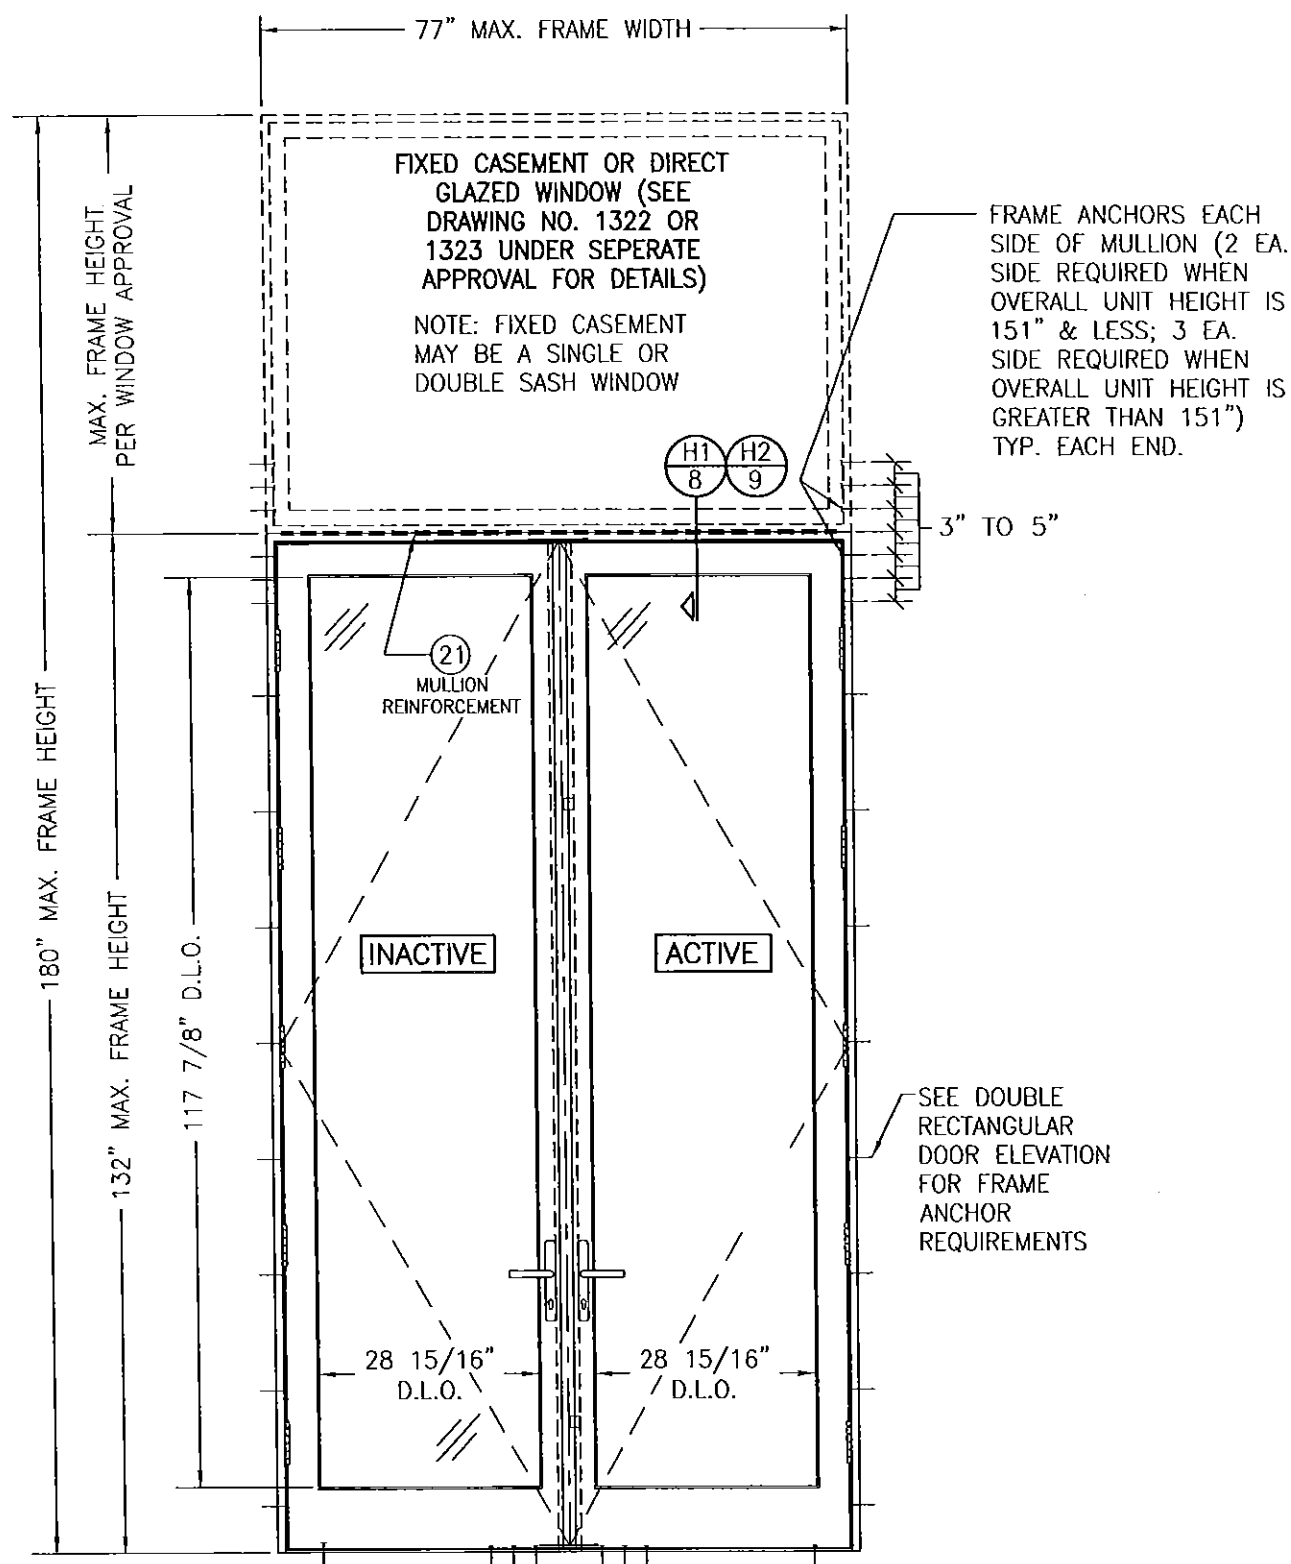

EXTERIOR ELEVATION
DOUBLE DOOR WITH TRANSOM

SCALE: 3/4" = 1'-0"

SEE DOUBLE RECTANGULAR DOOR ELEVATION FOR
DOOR DETAIL NOT SHOWN

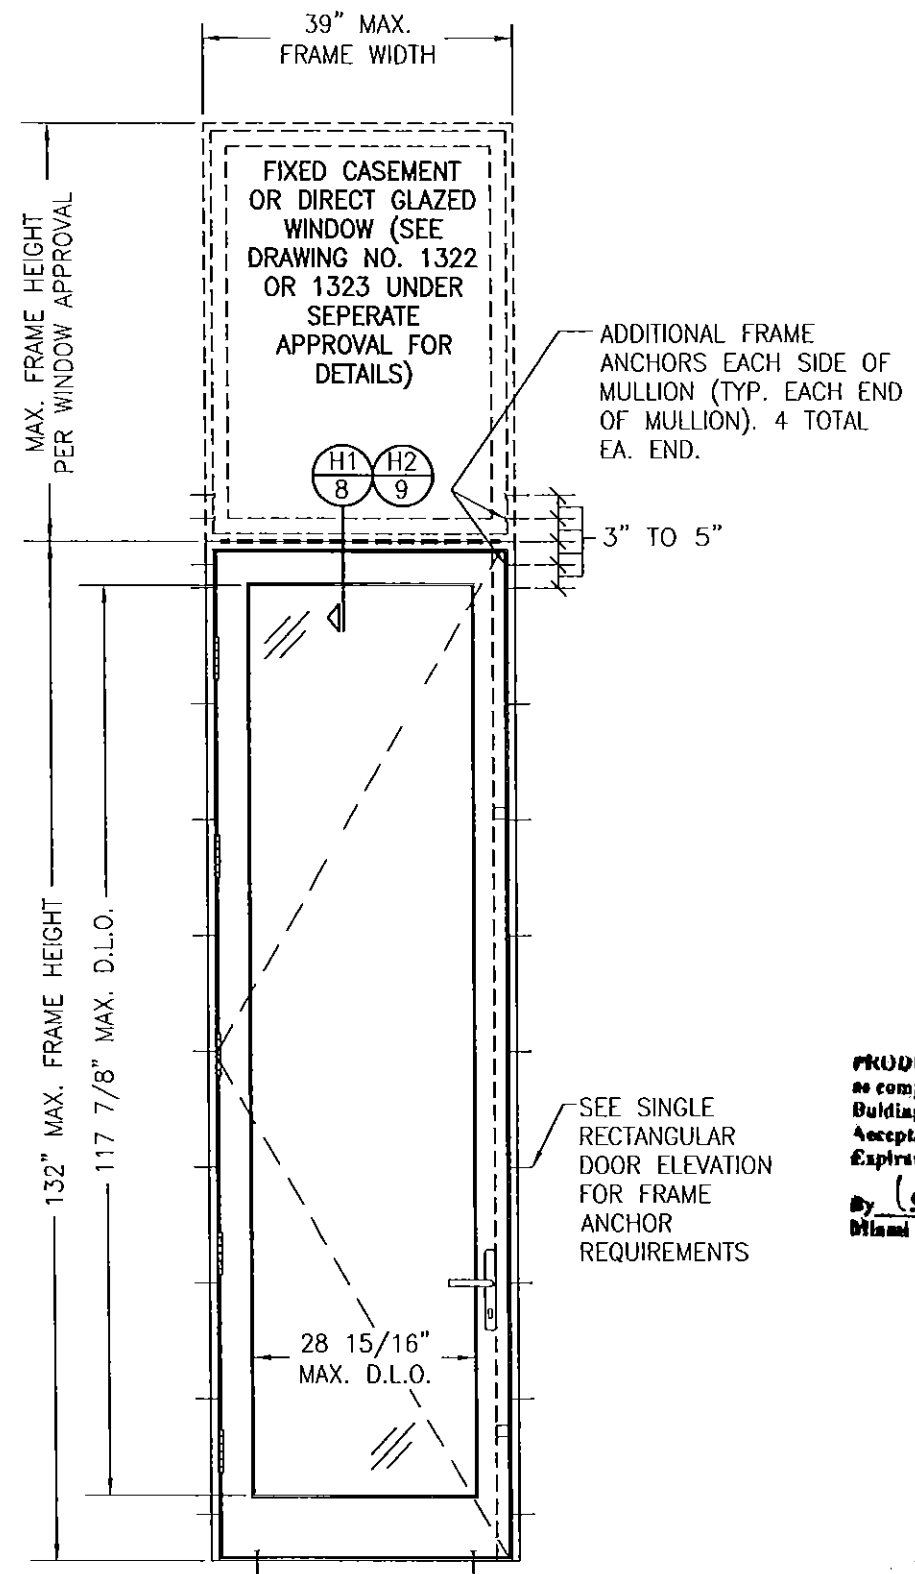

EXTERIOR ELEVATION
SINGLE DOOR WITH TRANSOM


SCALE: 3/4" = 1'-0"

SEE SINGLE RECTANGULAR DOOR ELEVATION
FOR DOOR DETAIL NOT SHOWN

NOTE: DOOR MAY ALSO BE A FIXED PANEL DOOR

PRODUCT REVISED
as complying with the Florida
Building Code
Acceptance No. 15-0414.11
Expiration Date 8/18/20
By *[Signature]*
Miami Dade Product Control


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PLOT: 1=24		DATE: 3/22/05	
NO.	REVISION	DESCRIPTION	DATE
DRAWING TITLE AMERICAN OUT-SWING IMPACT WOOD DOORS			
CONSULTANTS W. W. SCHAEFER ENGINEERING & CONSULTING, P.A. (CA 6809)		MANUFACTURER PEETZ WINDOWS & DOORS 15951 S.W. 41ST STREET, SUITE 150 WESTON, FL 33331 954-659-3887	
7480 150TH COURT NORTH PALM BEACH GARDENS, FL 33418 PHONE: 561-744-3424			
CERTIFICATION APR 06 2005		WARREN W. SCHAEFER P.E. P.E. NO. 44135	
DRAWING NO. 1324		REV. C	
SHEET NO. 3 OF 12			

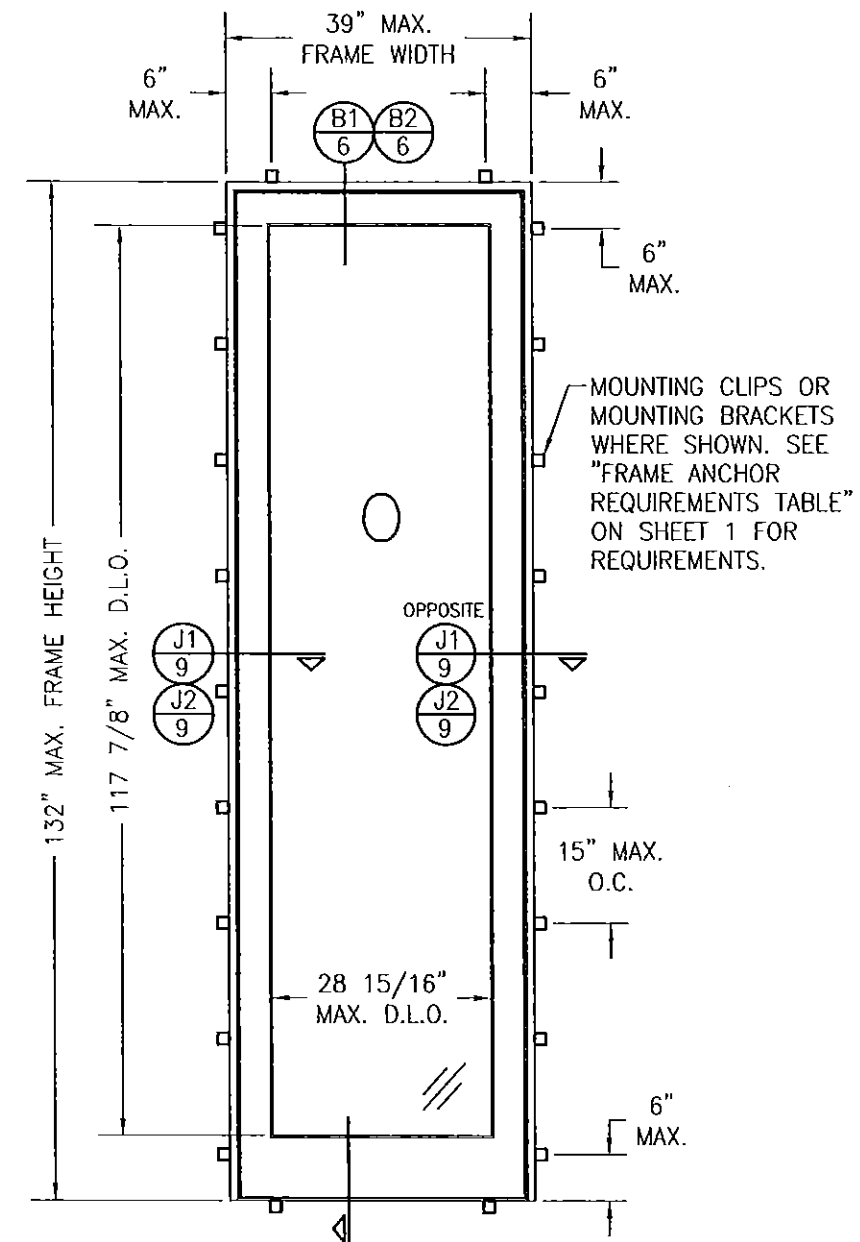


EXTERIOR ELEVATION
SINGLE FIXED PANEL
SCALE: 3/4" = 1'-0"

(OXXO UNIT SHOWN. ALL OTHER FIXED/OPERABLE COMBINATIONS ALSO APPLY WITH THE MULLION CONDITIONS SHOWN.)

CERTIFICATION		DRAWING TITLE	DRAWN BY: S.T.R.	CHECKED BY: W.W.S.
APR 06 2015		AMERICAN OUT-SWING IMPACT WOOD DOORS CONSULTANTS W. W. SCHAEFER ENGINEERING & CONSULTING, P.A. (CA 6809) 7480 150TH COURT NORTH PALM BEACH GARDENS, FL 33418 PHONE: 561-744-3424	PLOT: 1-24	DATE: 3/22/05
			NO.	REVISION DESCRIPTION
			BY	DATE
		MANUFACTURER	PEETZ WINDOWS & DOORS 15951 S.W. 41ST STREET; SUITE 150 WESTON, FL 33331 954-659-3887	
WARREN W. SCHAEFER, P.E. P.E. NO. 44135				
DRAWING NO. 1324		REV. C		
SHEET NO. 4 OF 12				





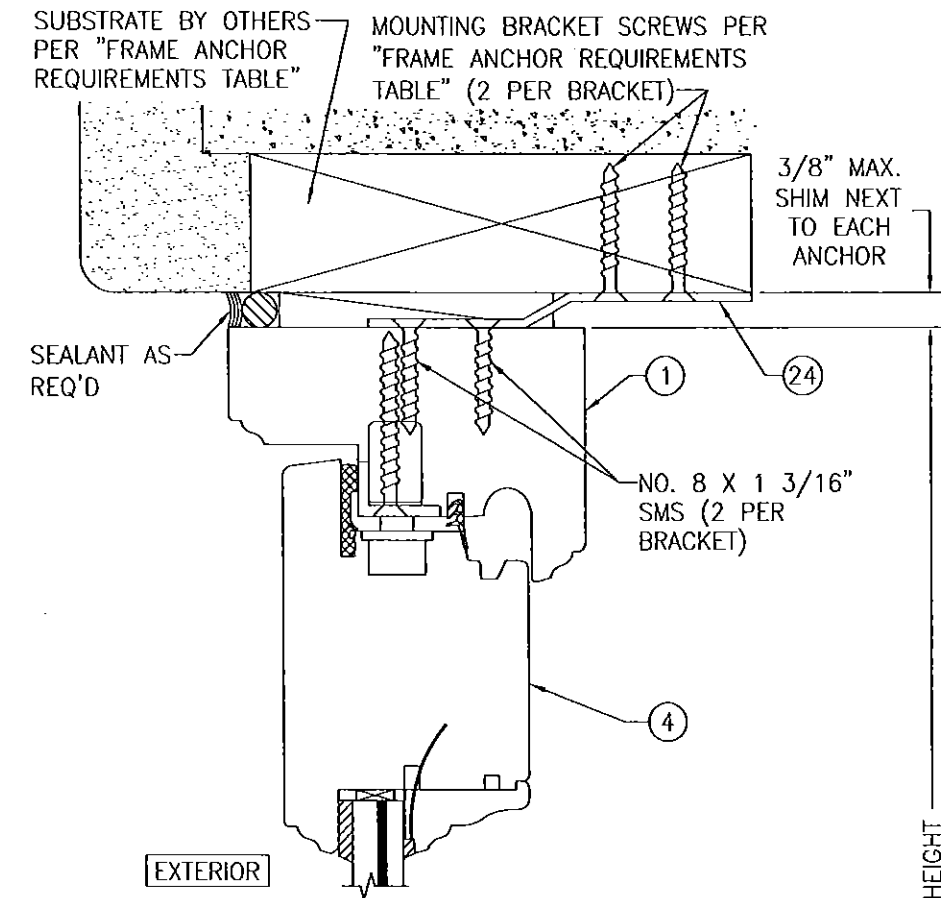


EXTERIOR

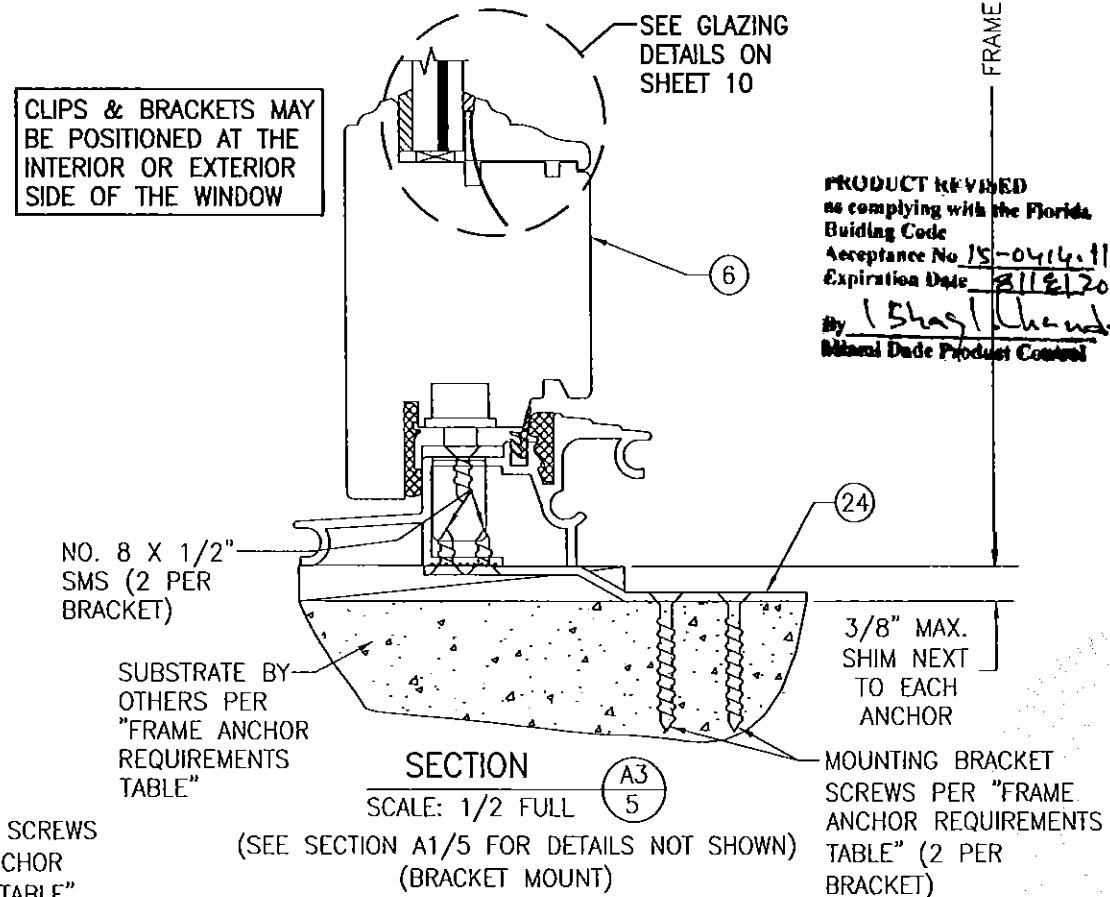


PRODUCT REVISED
as complying with the Florida
Building Code
Acceptance No. 15-0414.11
Expiration Date 3/18/20
by 15 Hagl, Chaud
Michael Dade Product Control

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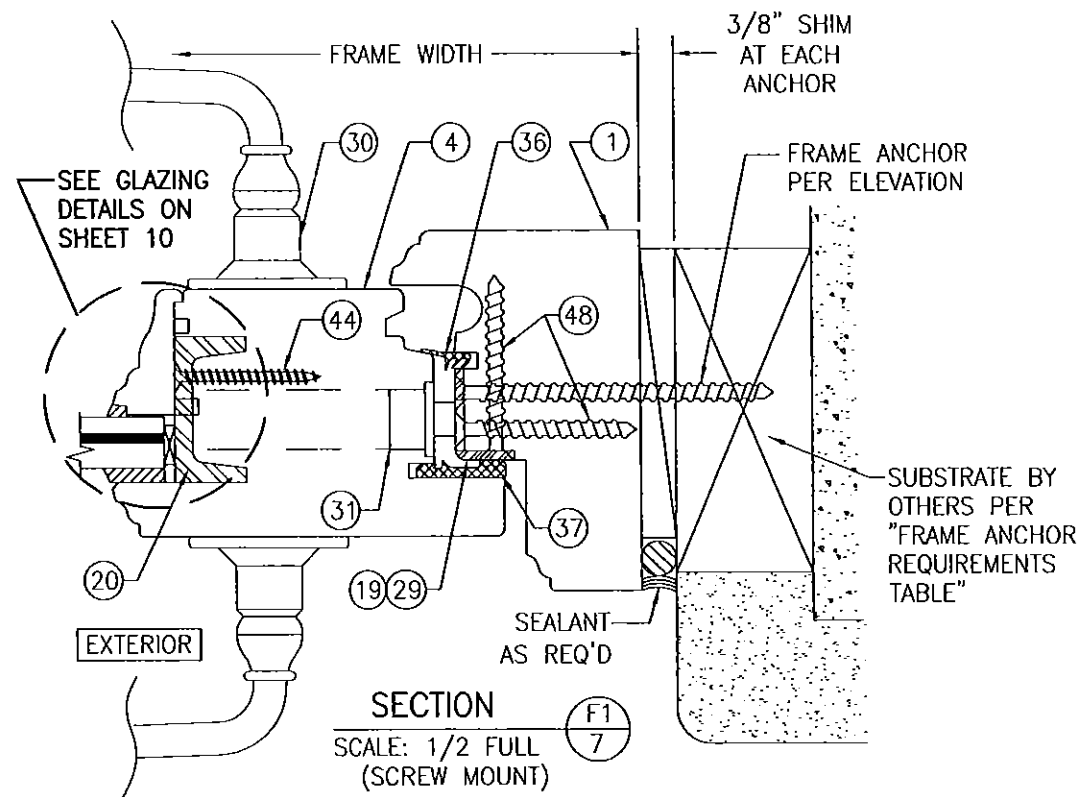
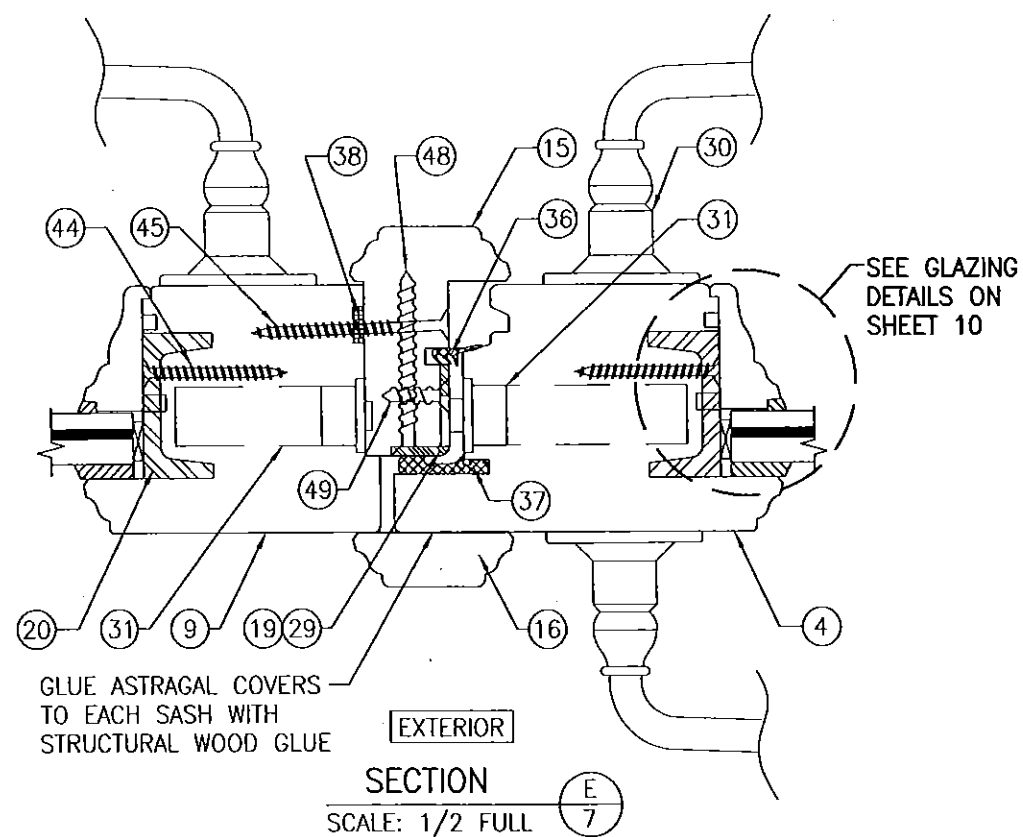
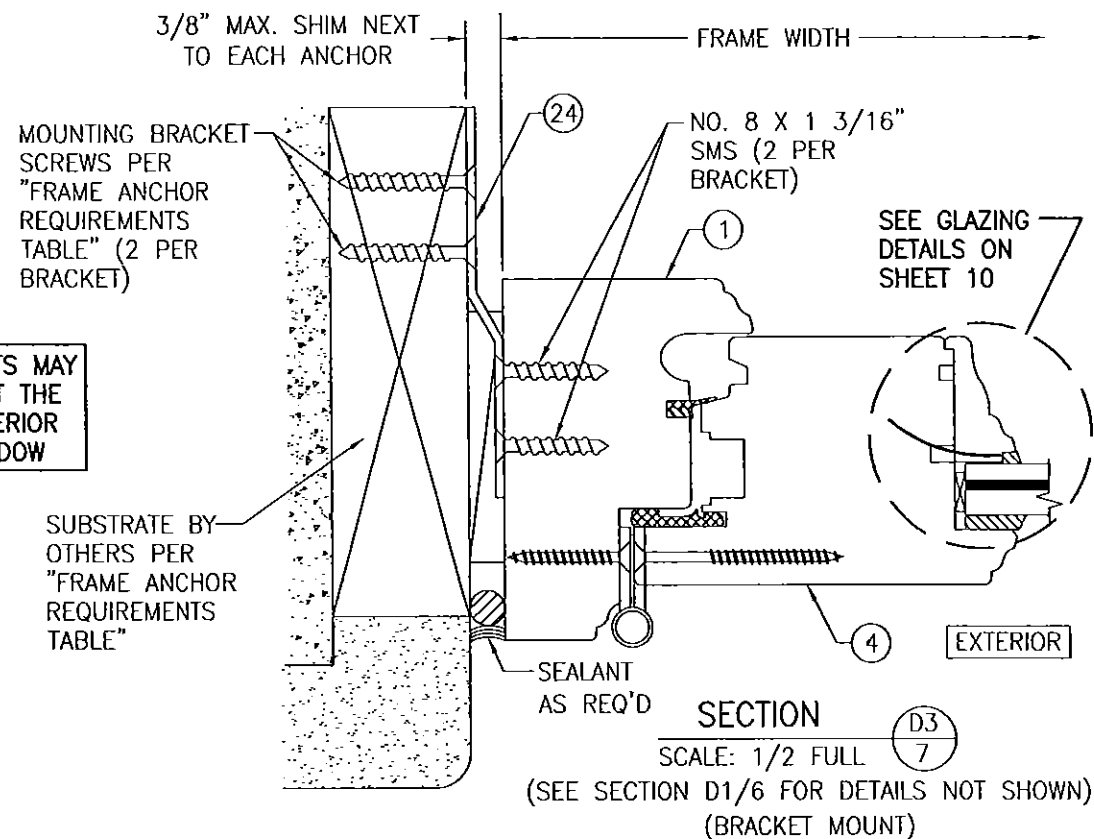


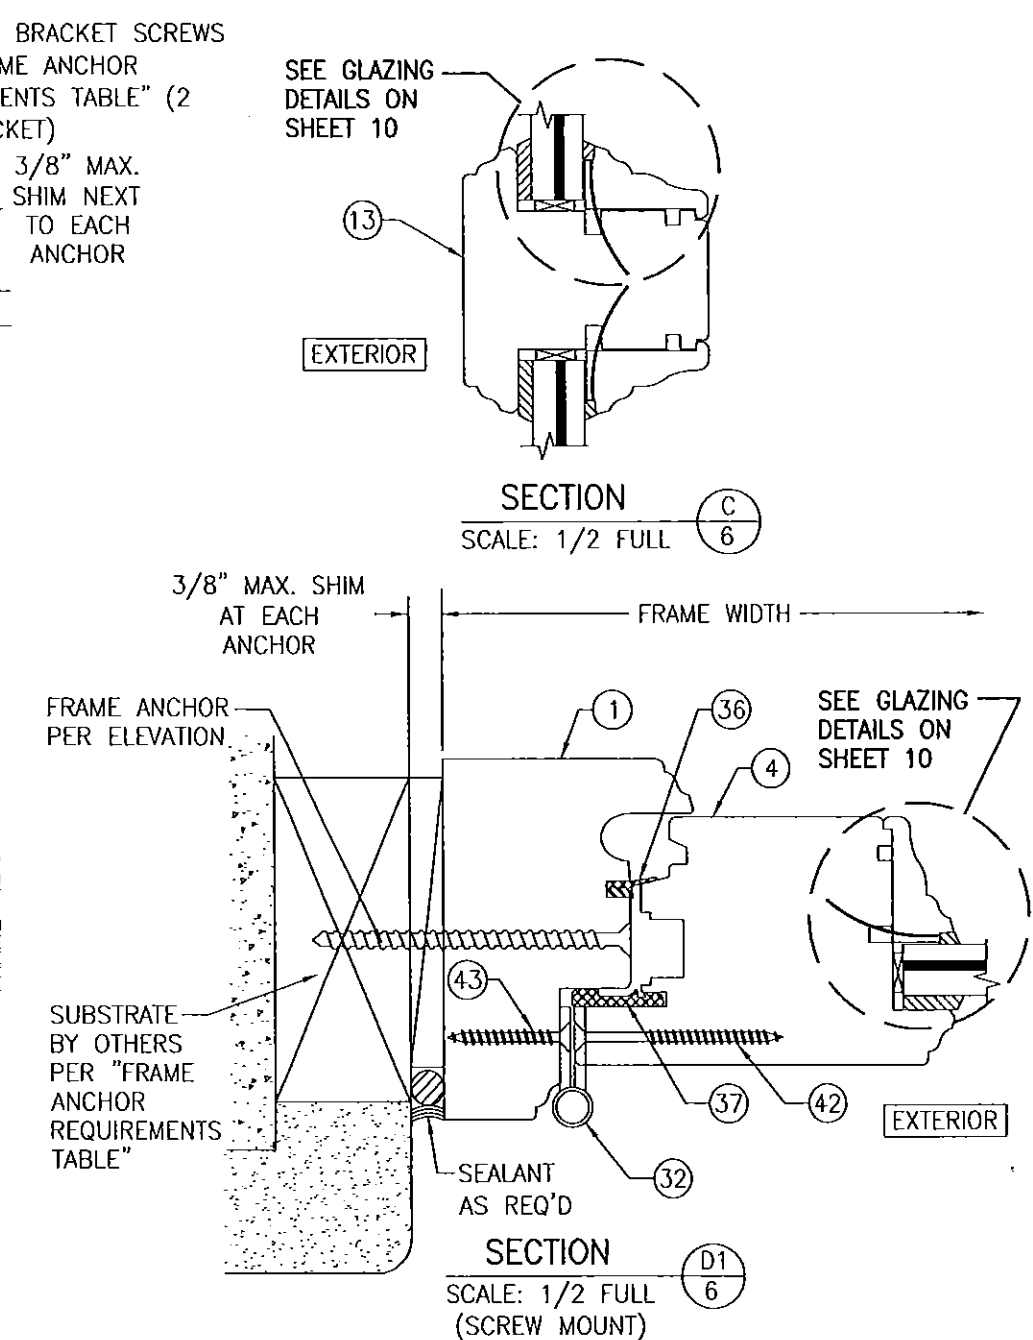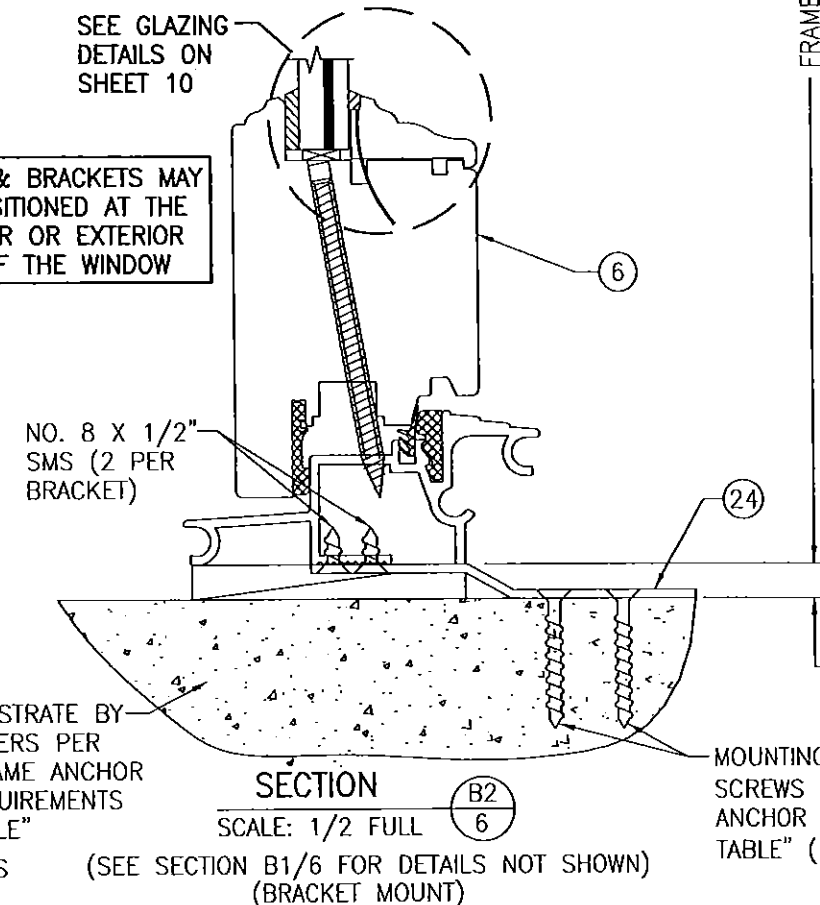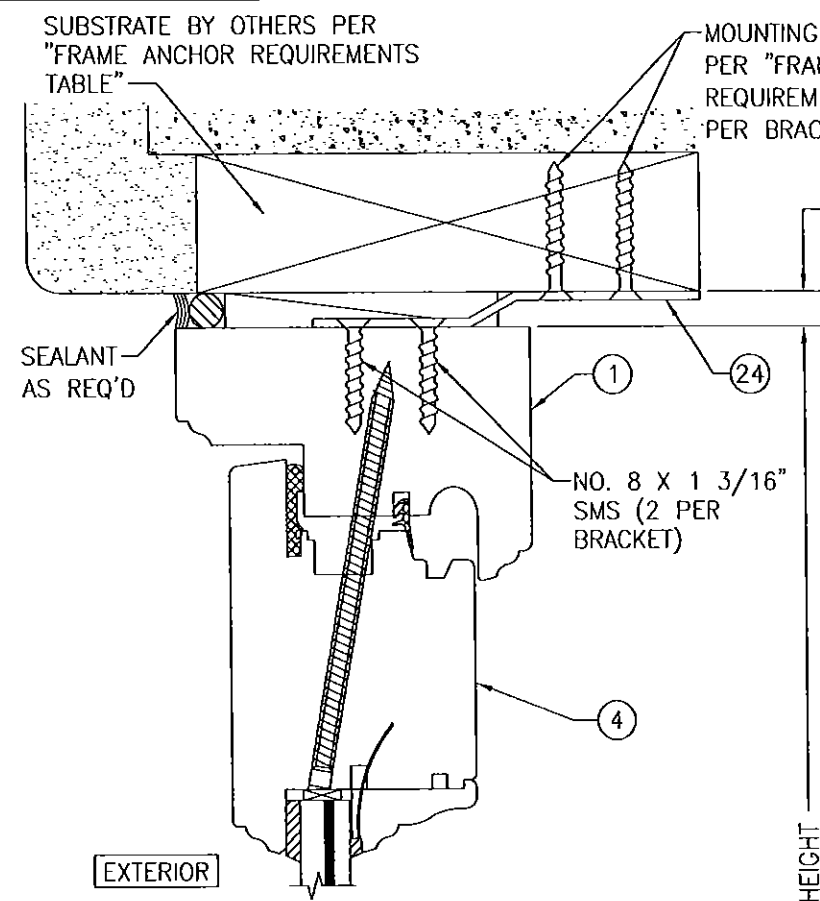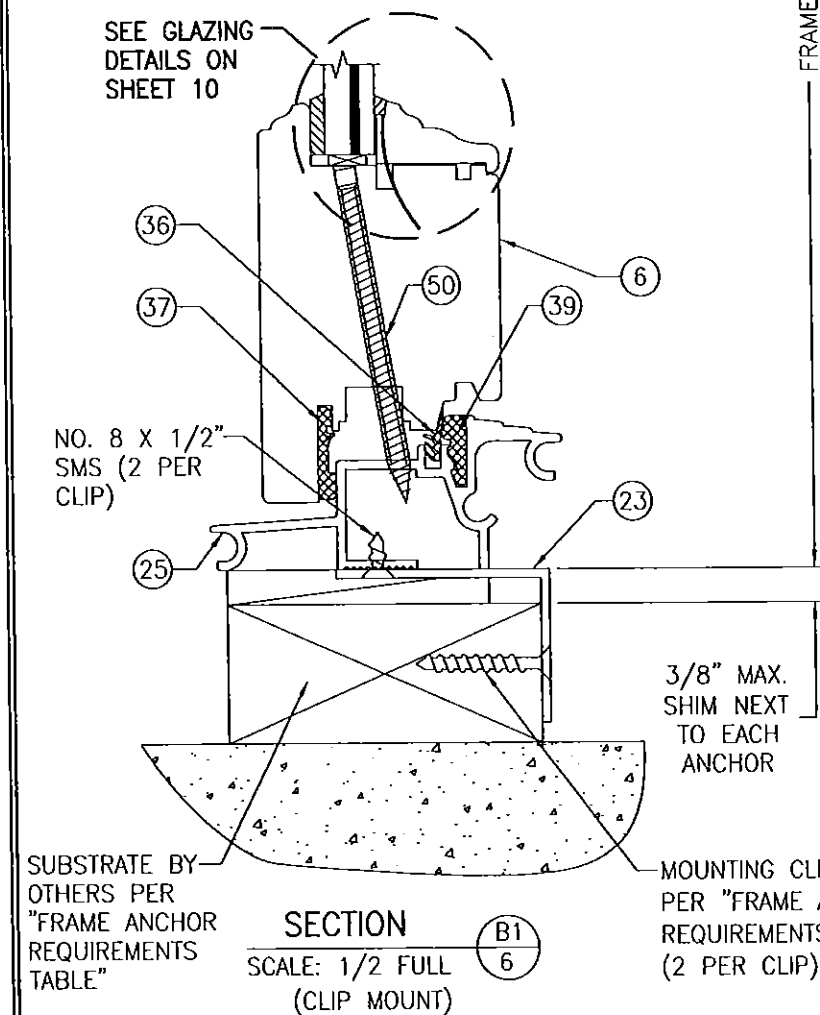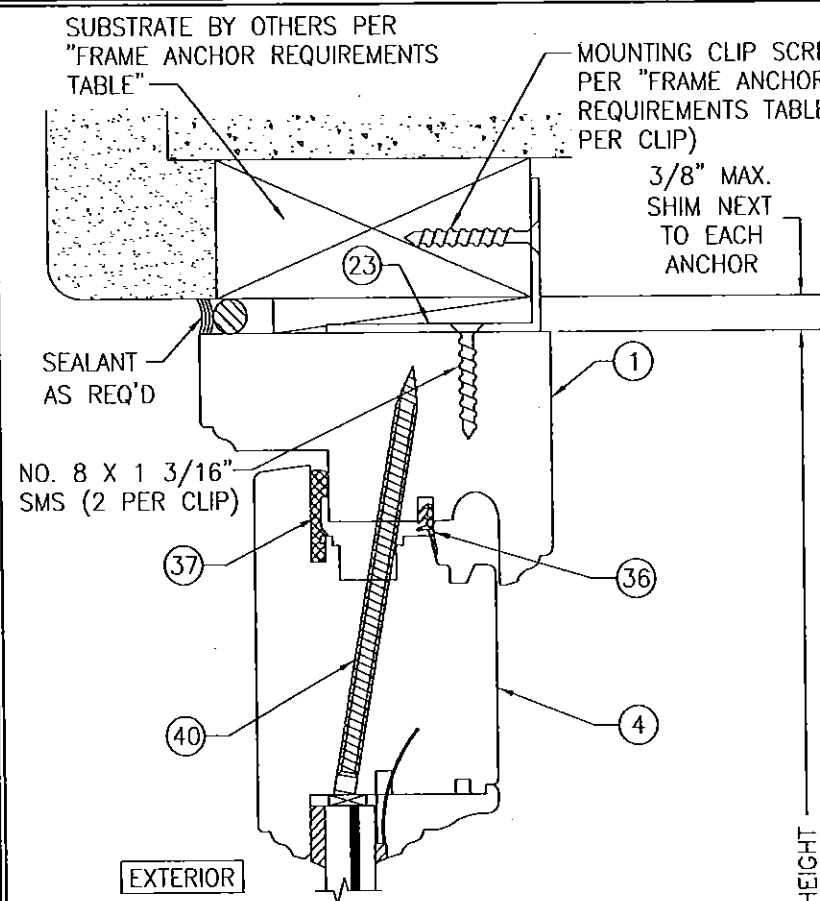PRODUCT REVISED
as complying with the Florida
Building Code
Acceptance No. 15-0714-11
Expiration Date 2/18/20
By Ishag L. Lhant
Miami Dade Product Control

DRAWN BY: S.T.R.	CHECKED BY: W.W.S.
PLOT: 1=2	DATE: 3/22/05
DATE	BY
REVISION DESCRIPTION	
NO.	
DRAWING TITLE AMERICAN OUT-SWING IMPACT WOOD DOORS	
CONSULTANTS W. W. SCHAEFER ENGINEERING & CONSULTING, P.A. (CA 6809)	MANUFACTURER PEETZ WINDOWS & DOORS 15951 S.W. 41ST STREET, SUITE 150 WESTON, FL 33331 954-659-3887
7480 150TH COURT NORTH PALM BEACH GARDENS, FL 33418 PHONE: 561-744-3424	
CERTIFICATION APR 06 2015	WARREN W. SCHAEFER, P.E. P.E. NO. 44135
DRAWING NO. 1324	REV. C
SHEET NO. 6 OF 12	

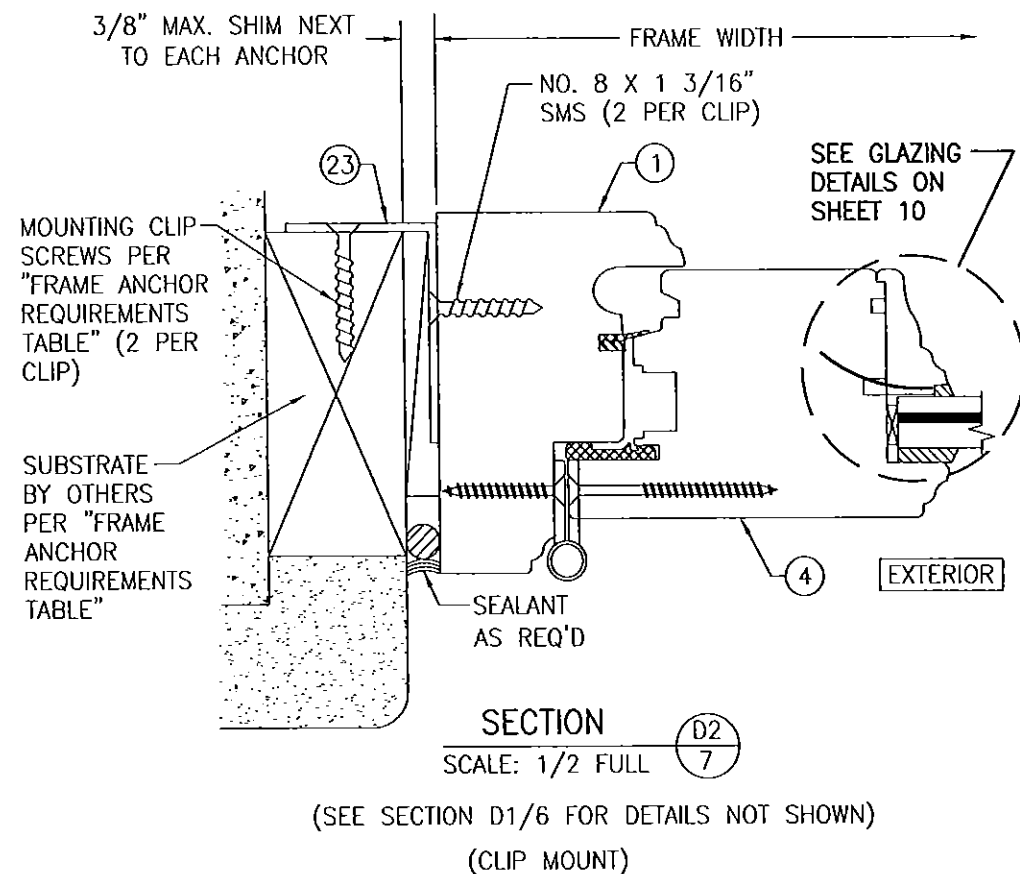


CLIPS & BRACKETS MAY BE POSITIONED AT THE INTERIOR OR EXTERIOR SIDE OF THE WINDOW




PRODUCT REVISED
as complying with the Florida
Building Code
Acceptance No. 15-0414-11
Expiration Date 8/18/20
By: *[Signature]*
Miami Dade Product Control


DRAWN BY: S.T.R.		CHECKED BY: W.W.S.	
PLOT: 1=2		DATE: 3/22/05	
DATE	BY	REVISION	DESCRIPTION
NO.	NO.	NO.	NO.
DRAWING TITLE			
AMERICAN OUT-SWING IMPACT WOOD DOORS			
CONSULTANTS			
W. W. SCHAEFER ENGINEERING & CONSULTING, P.A. (CA 6809)			
7480 150TH COURT NORTH			
PALM BEACH GARDENS, FL 33418			
PHONE: 561-744-3424			
MANUFACTURER			
PEETZ WINDOWS & DOORS			
15951 S.W. 41ST STREET, SUITE 150			
WESTON, FL 33331			
954-659-3887			
CERTIFICATION			
APR 06 2005			
DRAWING NO. 1324			
REV. C			
SHEET NO. 7 OF 12			

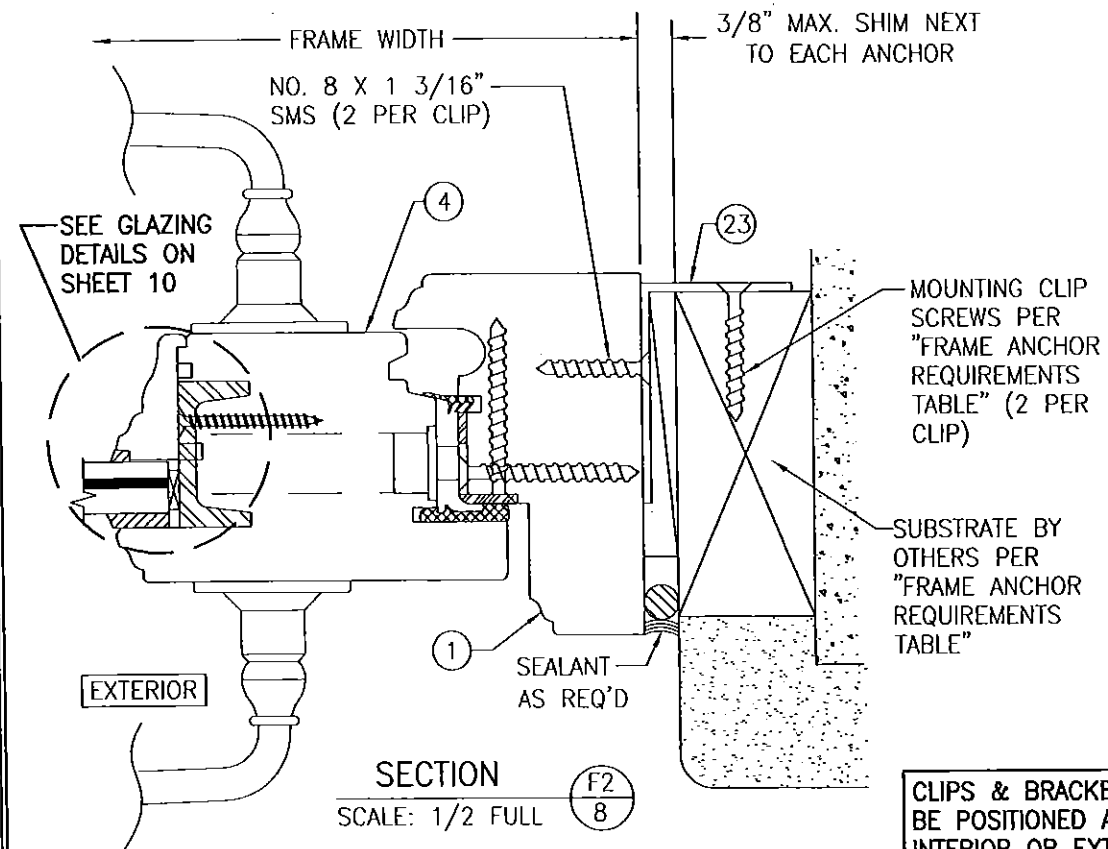

SECTION F2
SCALE: 1/2 FULL
(SEE SECTION F1/7 FOR DETAILS NOT SHOWN)
(CLIP MOUNT)

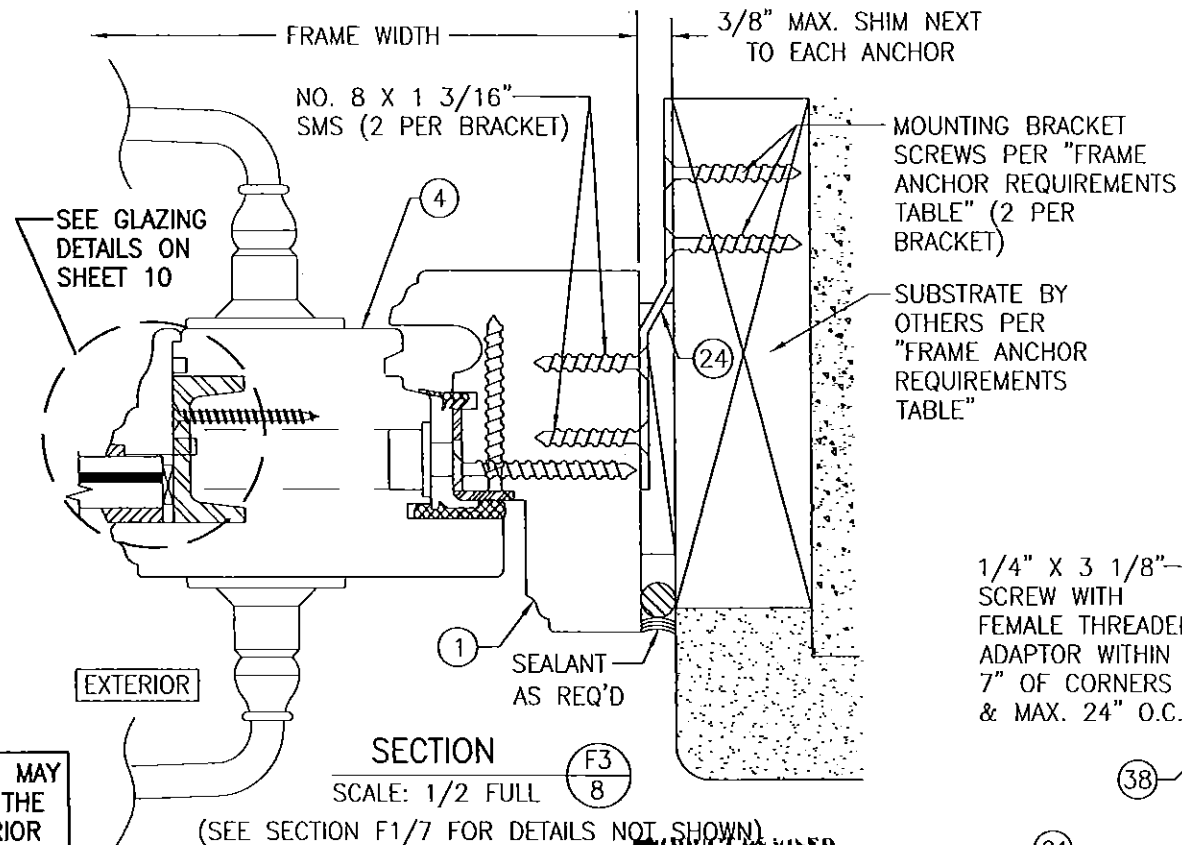


SECTION F3
SCALE: 1/2 FULL
(SEE SECTION F1/7 FOR DETAILS NOT SHOWN)
(BRACKET MOUNT)

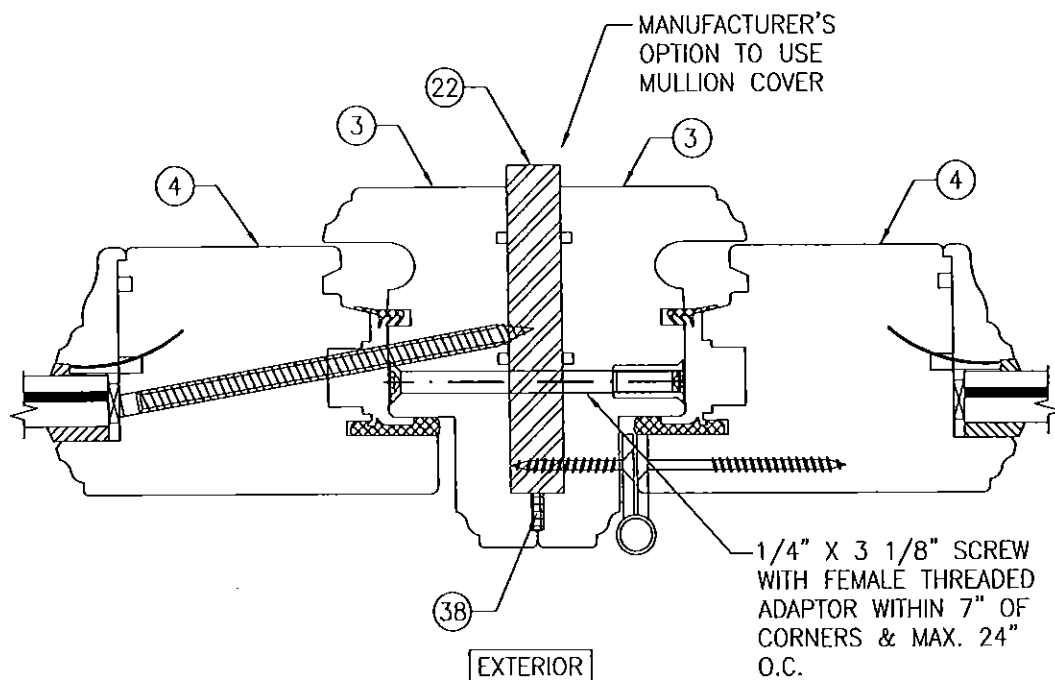


SECTION G1
SCALE: 1/2 FULL
(SEE OTHER SECTIONS FOR DETAIL NOT SHOWN)

FIXED CASEMENT WINDOW UNDER SEPARATE APPROVAL

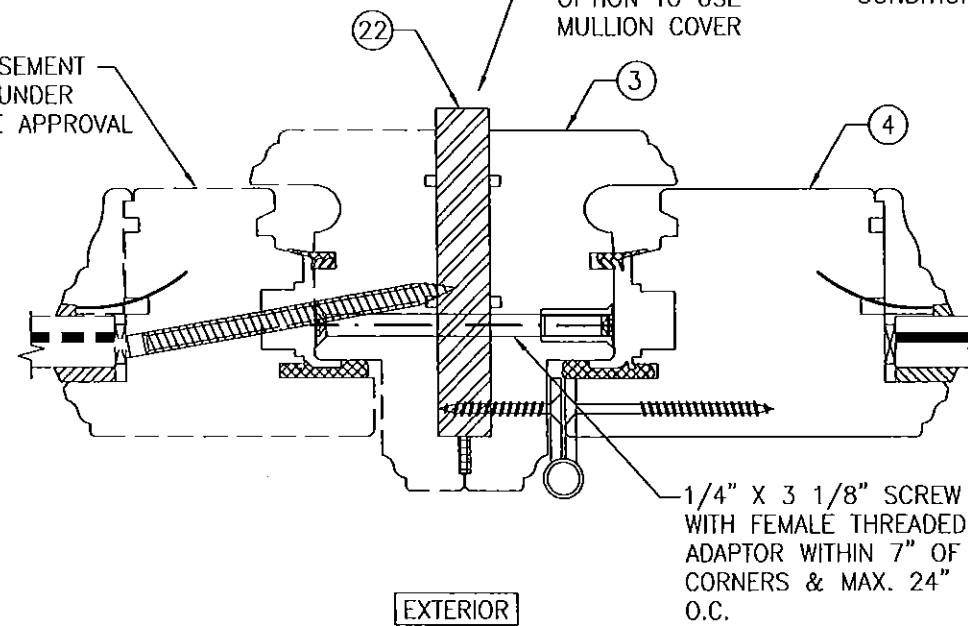

SECTION G2
SCALE: 1/2 FULL
(SEE OTHER SECTIONS FOR DETAIL NOT SHOWN)

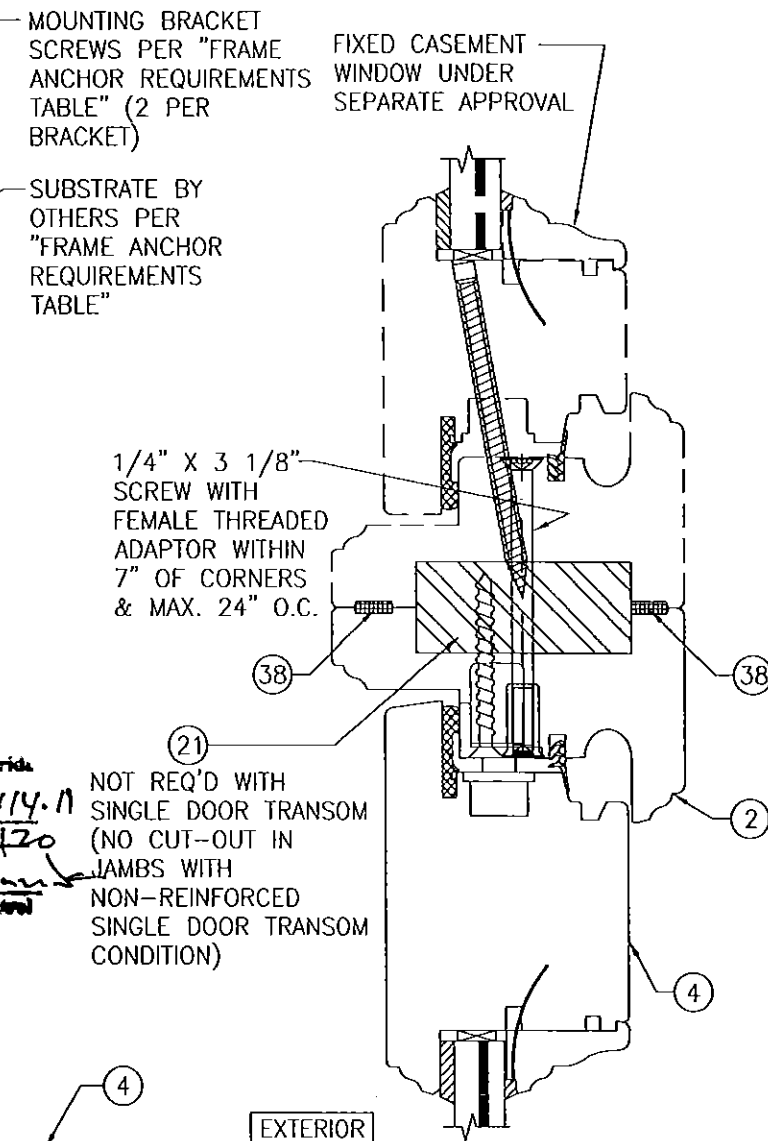


SECTION H1
SCALE: 1/2 FULL
(SEE OTHER SECTION FOR DETAIL NOT SHOWN)

PRODUCT REVISED
as complying with the Florida
Building Code
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Expiration Date 8/18/20

By Michael Dade Product Control
MANUFACTURER'S
OPTION TO USE
MULLION COVER


NOT REQ'D WITH
SINGLE DOOR TRANSOM
(NO CUT-OUT IN
JAMBS WITH
NON-REINFORCED
SINGLE DOOR TRANSOM
CONDITION)

DRAWN BY: S.T.R.		CHECKED BY: W.W.S.	
PLOT: 1=2		DATE: 3/22/05	
NO.	REVISION	DESCRIPTION	DATE
DRAWING TITLE: AMERICAN OUT-SWING IMPACT WOOD DOORS			
CONSULTANTS		MANUFACTURER	
W. W. SCHAEFER ENGINEERING & CONSULTING, P.A. (CA 6809)		PEETZ WINDOWS & DOORS	
7480 150TH COURT NORTH PALM BEACH GARDENS, FL 33418 PHONE: 561-744-3424		15951 S.W. 41ST STREET, SUITE 150 WESTON, FL 33331 954-659-3887	
CERTIFICATION: APR 06 2015			
DRAWING NO. 1324		REV. C	
SHEET NO. 8 OF 12			

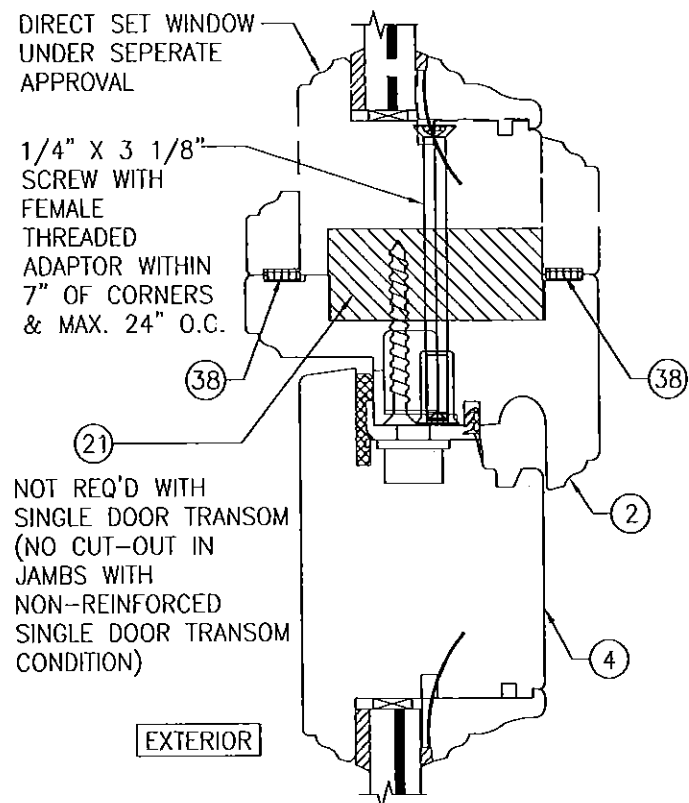


SECTION H2
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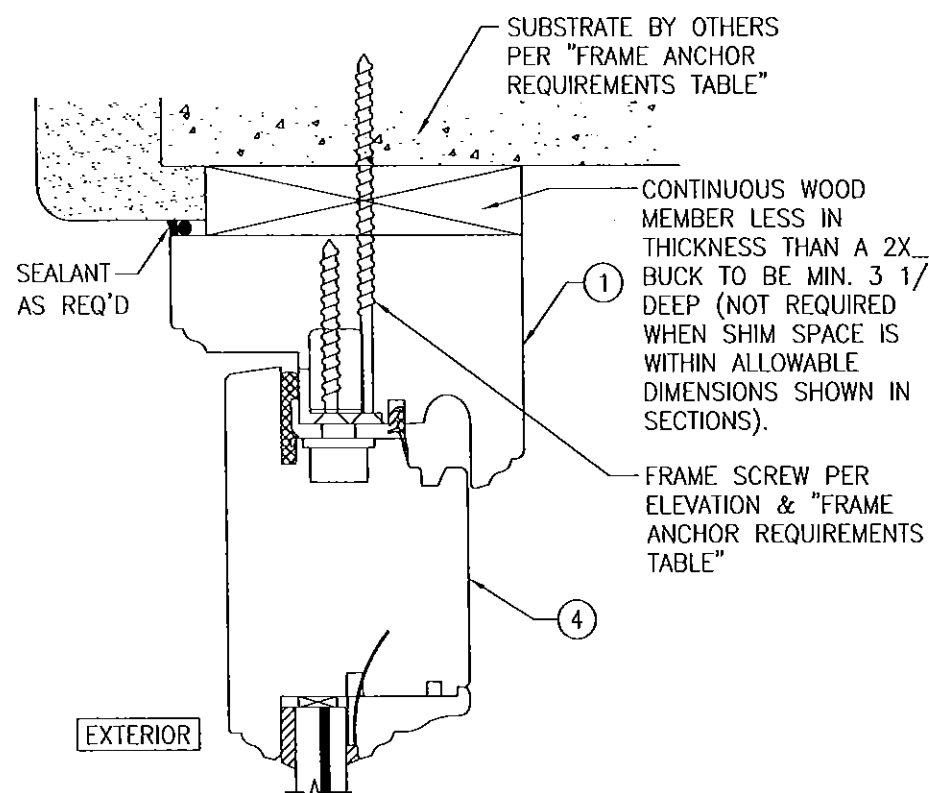
(SEE OTHER SECTION FOR DETAIL NOT SHOWN)

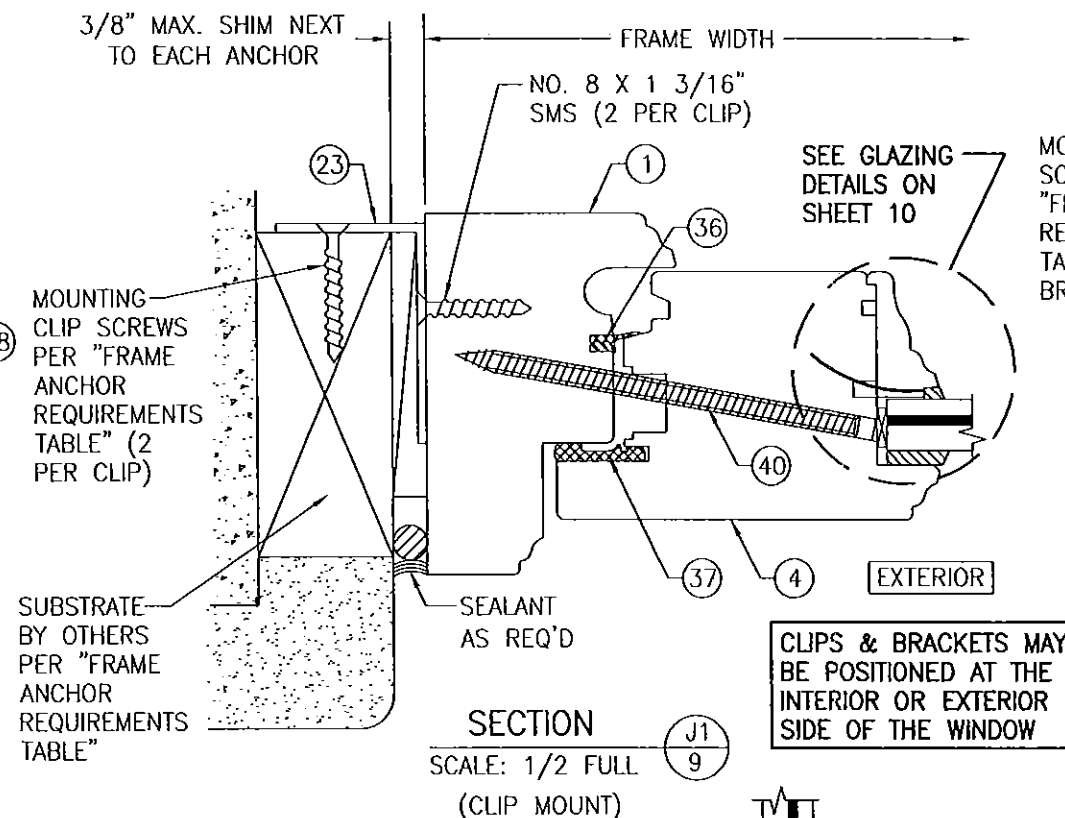

SECTION J1
SCALE: 1/2 FULL
(CLIP MOUNT)

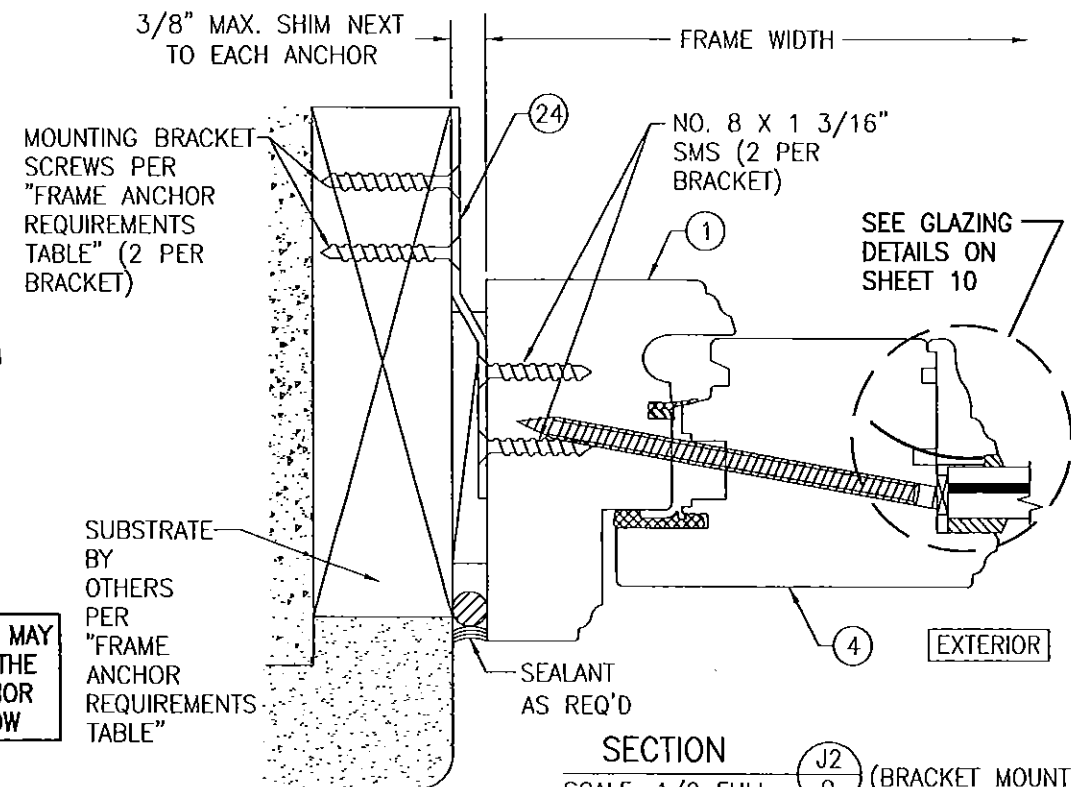


SECTION J2
SCALE: 1/2 FULL
(BRACKET MOUNT)
(SEE SECTION J1/9 FOR DETAILS NOT SHOWN)



OPTIONAL DIRECT MOUNT DETAIL
TO SUBSTRATE WITH SPACER


(HEAD SECTION SHOWN; SILL & SIDES ARE INSTALLED THE SAME)
(FOR DETAIL NOT SHOWN, SEE OTHER SECTIONS)

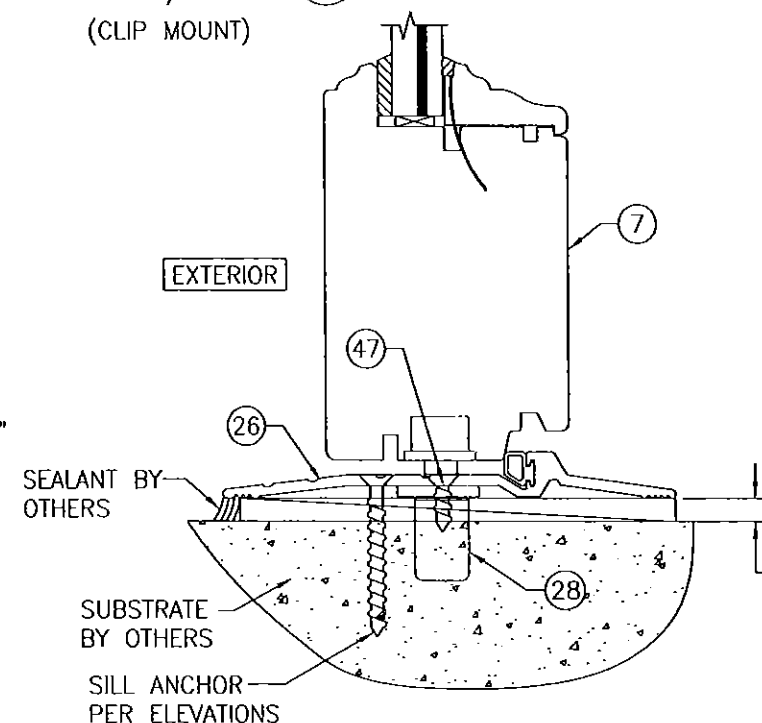

OPTIONAL ADA THRESHOLD DETAIL


ADA NOTE: WHEN ADA SILL IS USED, THESE DOORS ARE NOT APPROVED FOR USE WHERE WATER INFILTRATION RESISTANCE IS REQUIRED BY THE DOOR. UNLESS UNITS ARE INSTALLED IN NON-HABITABLE AREAS WHERE THE UNIT & THE AREA ARE DESIGNED TO ACCEPT WATER INFILTRATION, UNITS SHALL BE INSTALLED ONLY AT LOCATIONS PROTECTED BY A CANOPY OR OVERHANG WHERE-BY THE OVERHANG(OH) RATIO IS EQUAL TO OR MORE THAN 1.0 PER FBC CHAPTER 24.

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By: [Signature]
Product Control

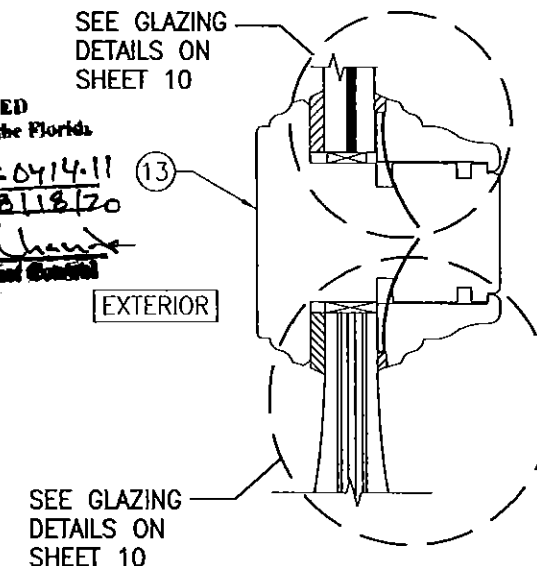


SECTION K
SCALE: 1/2 FULL

DRAWN BY: S.T.R.	CHECKED BY: W.W.S.
PLOT: 1-2	DATE: 3/22/05
DATE	BY
REVISION DESCRIPTION	NO.
DRAWING TITLE AMERICAN OUT-SWING IMPACT WOOD DOORS	
CONSULTANTS W. W. SCHAEFER ENGINEERING & CONSULTING, P.A. (CA 6809)	MANUFACTURER PEETZ WINDOWS & DOORS 15951 S.W. 41ST STREET, SUITE 150 WESTON, FL 33331 954-659-3887
CERTIFICATION APR 06 2015	WARREN W. SCHAEFER, P.E. P.E./NO. 44135
DRAWING NO. 1324	REV. C
SHEET NO. 9	OF 12

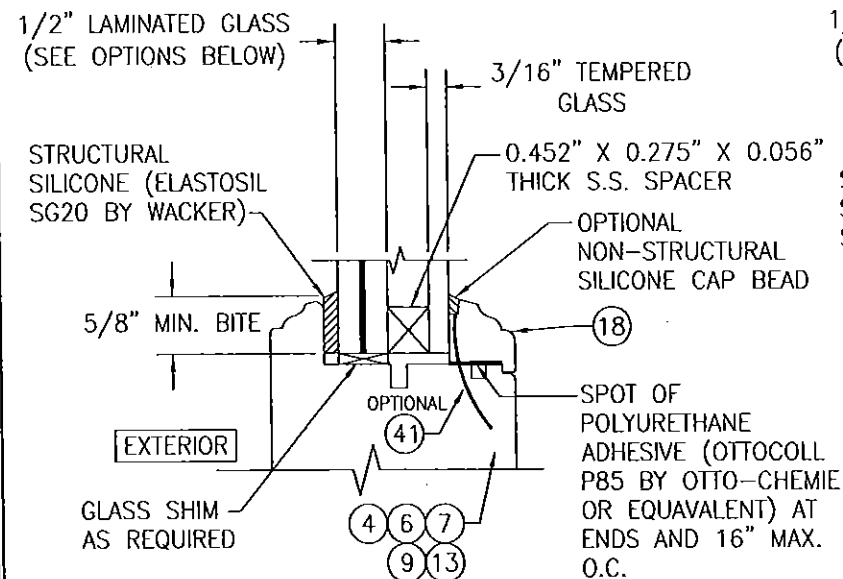


I.G. GLAZING DETAIL

- GLASS OPTION:**
- 1/2" THICK LAMINATED OUTER GLASS (3/16" AN/0.09 EASTMAN CHEMICAL CO. "SAFLEX"/1/4" AN); 3/16" TEMPERED SINGLE PANE INNER GLASS & 1/2" AIR SPACE
 - 1/2" THICK LAMINATED OUTER GLASS (3/16" AN/0.075 EASTMAN CHEMICAL CO. "SAFLEX CP"/1/4" AN); 3/16" TEMPERED SINGLE PANE INNER GLASS & 1/2" AIR SPACE

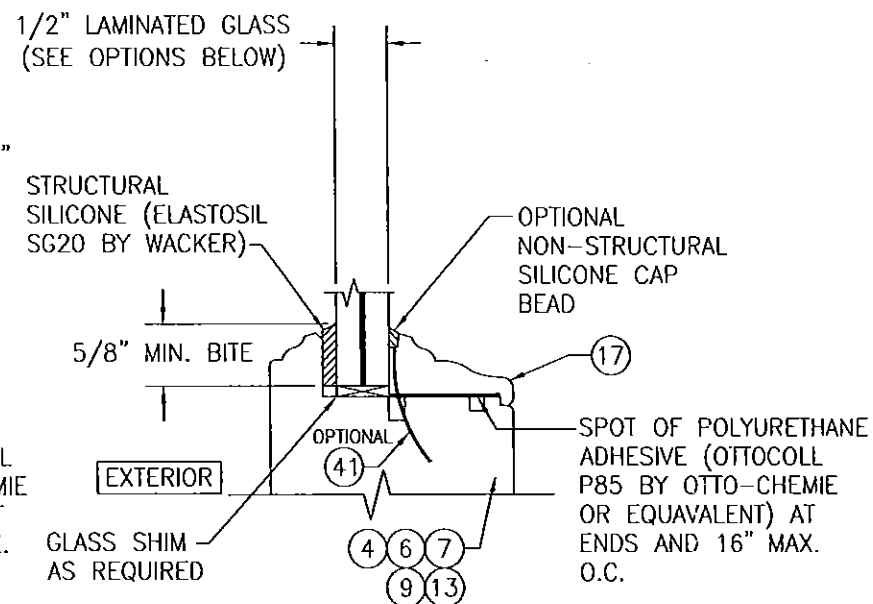


NON-I.G. GLAZING DETAIL


- GLASS OPTION:**
- 1/2" THICK LAMINATED GLASS (3/16" AN/0.09 EASTMAN CHEMICAL CO. "SAFLEX"/1/4" AN)
 - 1/2" THICK LAMINATED GLASS (3/16" AN/0.075 EASTMAN CHEMICAL CO. "SAFLEX CP"/1/4" AN)

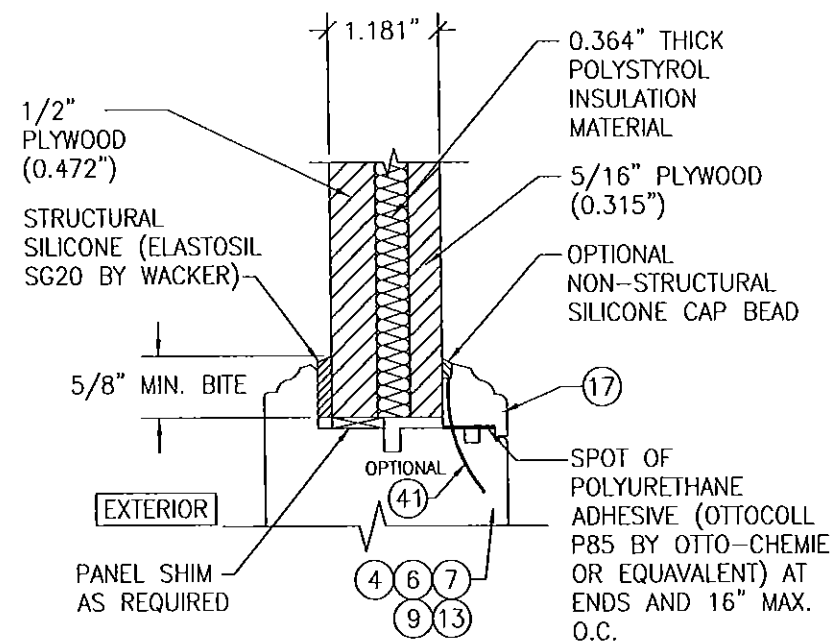


FLUSH PANEL GLAZING DETAIL

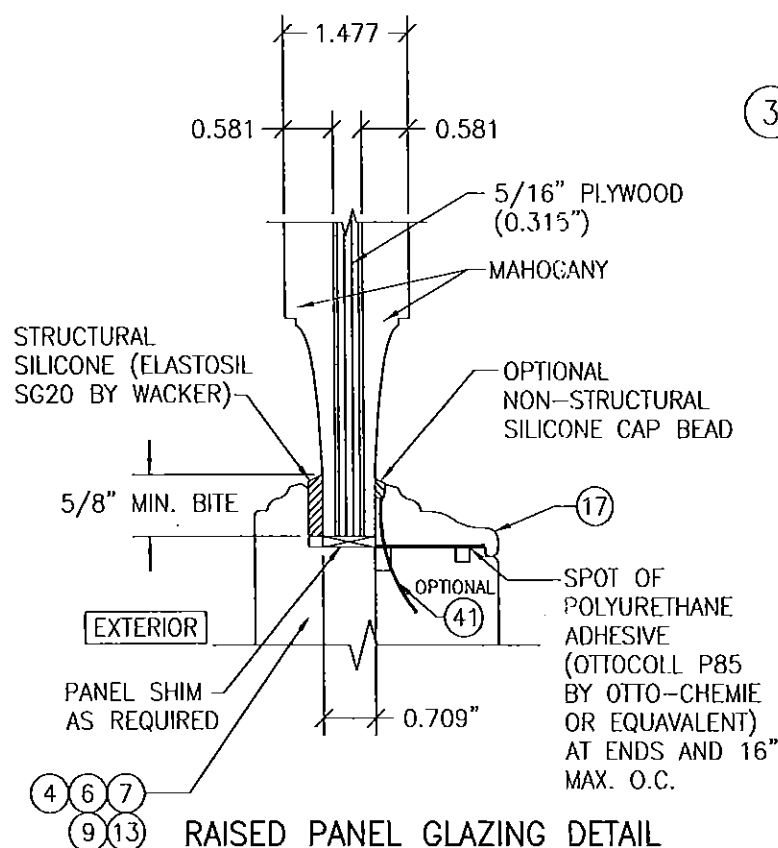


RAISED PANEL GLAZING DETAIL

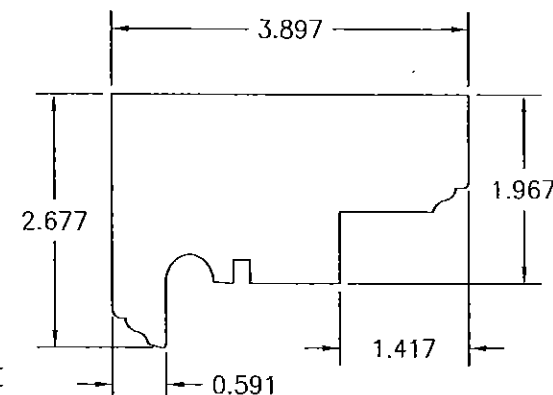


1 HEAD AND SIDE JAMB

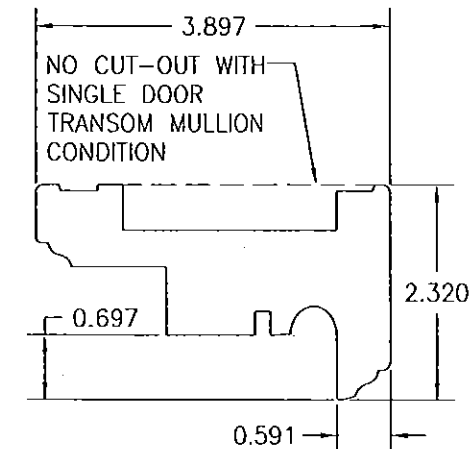


2 MULLION HEAD JAMB

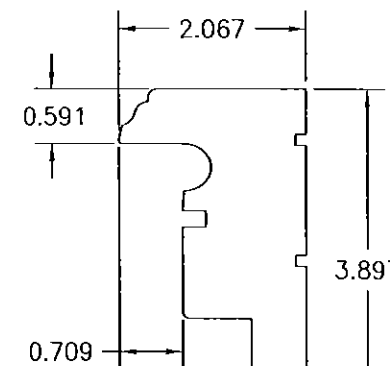


3 MULLION SIDE JAMB

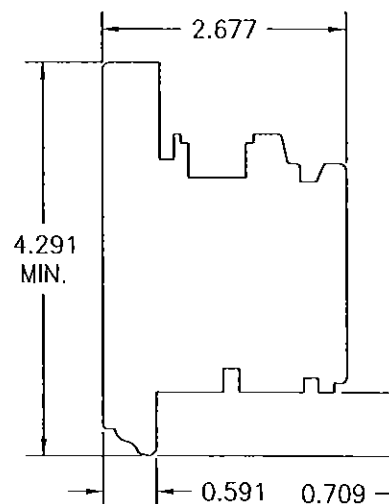

4 STILE AND TOP RAIL

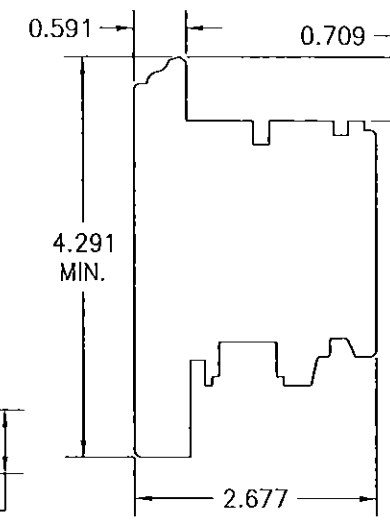

6 BOTTOM RAIL (BUMPER SILL)

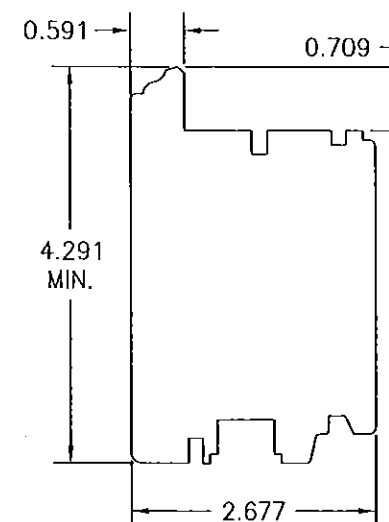

7 BOTTOM RAIL (ADA SILL)

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By *Shag L. Gault*
Miami Dade Product Control

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NO.	REVISION	DESCRIPTION	DATE
1			


DRAWING TITLE: AMERICAN OUT-SWING IMPACT WOOD DOORS

MANUFACTURER:
PEETZ WINDOWS & DOORS
15951 S.W. 41ST STREET, SUITE 150
WESTON, FL 33331
954-659-3887


CONSULTANTS:
W. W. SCHAEFER ENGINEERING & CONSULTING, P.A. (CA 6809)
7480 150TH COURT NORTH, SUITE 33418
PALM BEACH GARDENS, FL 33418
PHONE: 561-744-3424

CERTIFICATION
APR 06 2005
WARREN W. SCHAEFER, P.E.
P.E. NO. 44135


DRAWING NO. 1324
SHEET NO. 10 OF 12

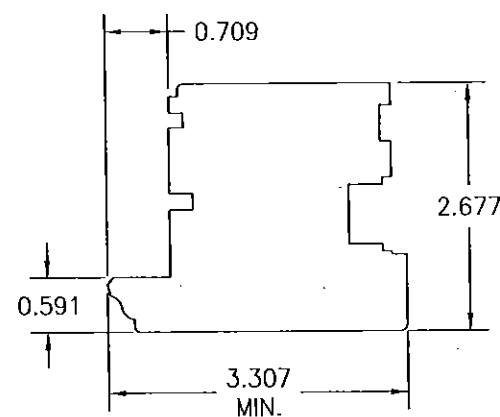


⑨ MEETING STILE

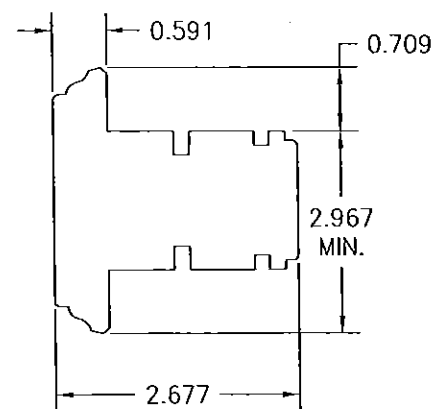


⑬ MID RAIL

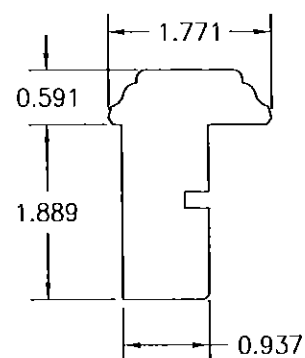


⑮ ASTRAGAL
(INACTIVE LEAF)

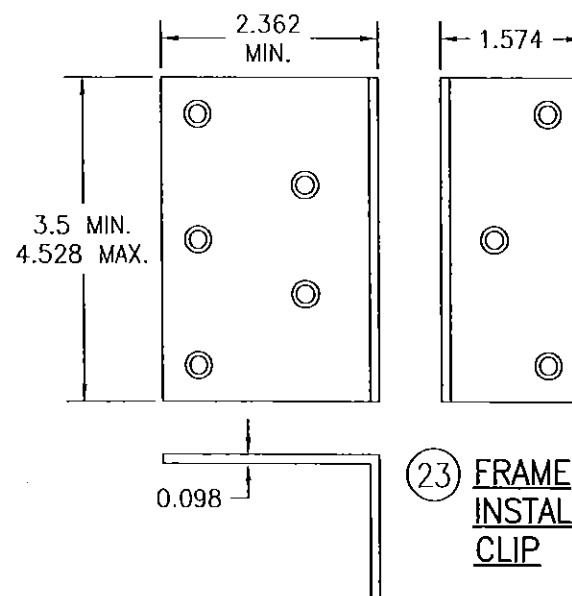


⑲ FRAME
INSTALLATION
CLIP

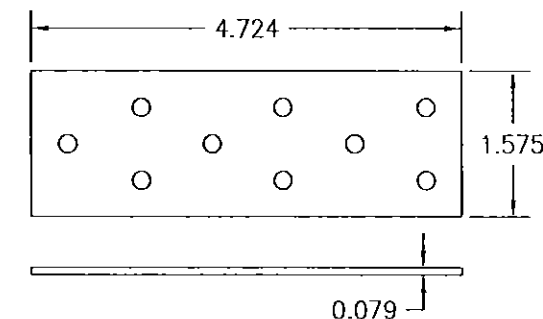


⑳ FRAME INSTALLATION
BRACKET

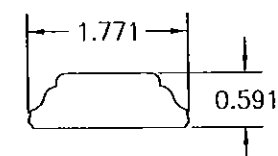


⑯ ASTRAGAL
COVER
(ACTIVE LEAF)

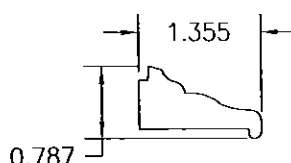


⑰ NON-I.G.
GLAZING BEAD

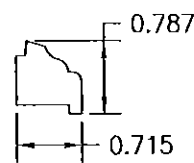


⑱ I.G. GLAZING
BEAD

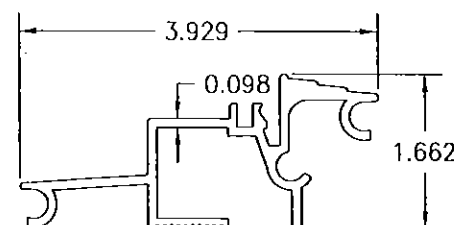


⑳ OUTSWING BUMPER
THRESHOLD

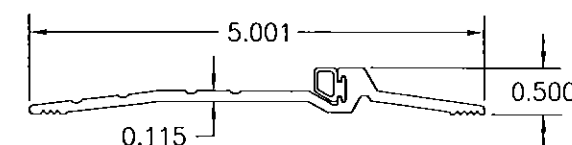


㉑ ADA THRESHOLD

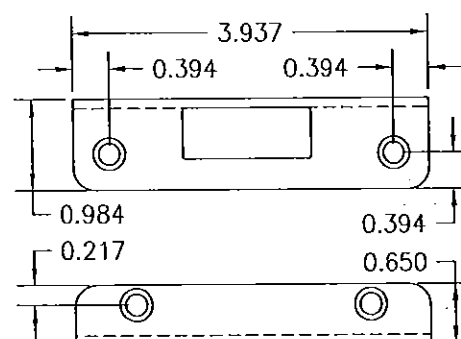


㉒ STRIKE PLATE

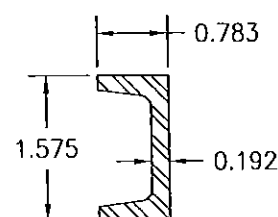


㉓ STILE
REINFORCEMENT

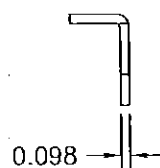

㉔ TRANSOM
MULLION
REINFORCEMENT

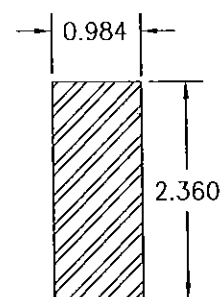

㉕ VERTICAL
MULLION
REINFORCEMENT

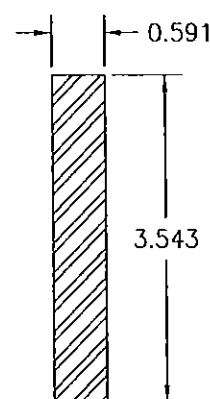

PRODUCT REVIEWED
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by Ishag I. Chaudhry
Miami Dade Product Control

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PLOT: 1-2		DATE: 3/22/05		
NO.	REVISION	DESCRIPTION	BY	DATE

